PRIVATE SITE IMPROVEMENTS

FOR

SHEETZ

2100 SOUTH ALEX ROAD **WEST CARROLLTON, OHIO 45449**





CLEVELAND

COLUMBUS

LOCATION MAP

NO SCALE

VICINITY MAP

NO SCALE

SURVEY PROVIDED BY:

Utilities Protection

1-800-362-2764 Call Before You Dig

CONTRACTOR TO VERIFY EXISTING CONDITIONS PRIOR TO BID AND

SERVICE

3601 RIGBY DRIVE, SUITE 300

MIAMISBURG, OH 45342 PHONE: 937.435.8584

DATED: 2022.11.11

CONSTRUCTION.

CESO, INC.

● WEST

CARROLLTON OHIO

AKRON

CANTON

CADIZ

Revisions / Submissions ID Description

763658 **Project Number:** 1" = 20' Drawn By: Checked By: 04.29.2024

Issue: NOT FOR CONSTRUCTION Drawing Title:

FORTY-EIGHT (48) HOURS BEFORE DIGGING IS TO COMMENCE, THE CONTRACTORS SHALL NOTIFY THE FOLLOWING AGENCIES: OHIO UTILITIES PROTECTION SERVICE AT 811 OR 1 (800) 362-2764

AND ALL OTHER AGENCIES WHICH MIGHT HAVE

UNDERGROUND UTILITIES INVOLVING THIS

PROJECT AND ARE NONMEMBERS OF OHIO

UTILITIES PROTECTION SERVICE

C1.0

TITLE SHEET

ENGINEER: OWNER/DEVELOPER: SKILKEN GOLD REAL ESTATE DEVELOPMENT 2800 CORPORATE EXCHANGE DR, SUITE 400

COLUMBUS, OH 43231 COLUMBUS, OH 43230 PHONE: (380) 799-5227 PHONE: (614) 935-0217 CONTACT: JOSH LONG CONTACT: AJ SCOTT EMAIL: JOSH.LONG@CESOINC.COM EMAIL: ascott@skilkengold.com

GOVERNING AGENCIES AND UTILITY COMPANIES:

SEWER: MIAMISBURG CITY PUBLIC WORKS 600 N. MAIN STREET MIAMISBURG, OH 45342 PHONE: (937) 847-6635 MONTGOMERY COUNTY ENVIRONMENTAL

SERVICES 1850 SPAULDING RD DAYTON, OH 45432 PHONE:(937) 781-2500

STORMWATER:
MONTGOMERY COUNTY ENVIRONMENTAL SERVICES 1850 SPAULDING RD DAYTON, OH 45432 PHONE: (937) 781-2500 ZONING: DEPARTMENT OF DEVELOPMENT

28 EAST MAIN STREET WEST JEFFERSON, OH 43162

PHONE: (614) 379-5250

1900 DRYDEN RD MORAINE, OH 45439 PHONE: (937) 331-3900 CABLE TELEVISION: CHARTER COMMUNICATIONS

GAS SERVICE:

6500 CLYO ROAD

208 S. AKARD ST.

DALLAS, TX 75202

PHONE: (210) 821-4105

DAYTON, OH 45459

PHONE: (800) 227-1376

COMMUNICATIONS

2834 MIAMISBURG-CENTERVILLE RD DAYTON, OH 45459 PHONE: (886) 874-2389

ENGINEER: 2800 CORPORATE EXCHANGE DR, SUITE 400 COLUMBUS, OH 43231 PHONE: (380) 799-5227 CONTACT: JOSH LONG EMAIL: JOSH.LONG@CESOINC.COM

EXISTING FEATURES LEGEND

APPLIES TO ALL CIVIL SHEETS

NOTE: THIS IS A GENERAL LEGEND THAT THE CESO SURVEY TEAM USES HOWEVER; PLEASE CHECK THE ALTA WITHIN THIS PLAN SET FOR THE FINAL EXISTING FEATURES LEGEND AS IT MAY INCLUDE UNIQUE OBJECTS


RIGHT OF WAY

				PARCEL PROPER EASEME CURB	TY BOUNDARY
				EDGE OF	PAVEMENT
				EDGE OF	WALK NT MARKINGS
	G			GAS LINE	Ē
	W			WATER L	INE
	UGE			UNDERG	ROUND ELECTR
	UGT			UNDERG	ROUND TELE
	OHL			OVERHE	AD UTILITY LINE
	STM			STORM S	SEWER
	SAN —			SANITAR	Y SEWER
		_	_	MAJOR C	CONTOURS
	— —		_	MINOR C	ONTOURS
(W)	WATER METER			\oplus	STORM CATCH
\otimes	WATER VALVE				STORM INLET
_				_	

CH BASIN BASIN FIRE HYDRANT **C**— GUY WIRE ANCHOR POWER/TELE POLE STORM MANHOLE © STORM CLEANOUT POWER POLE AIR CONDITIONER SANITARY MANHOLE SANITARY CLEANOUT LIGHT POLE TRAFFIC MANHOLE GAS VALVE ∮ SIGN GAS METER ϕ TELEPHONE POLE

FIRE HYDRANT

BENCHMARK

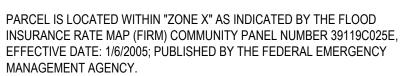


	BENCHMARK
V	Vertical Datum: NAVD88
	derived from GPS Observations
BM "A":	Bench tie set in a light pole located on the west side of the site approximately 3' east of the east curb of Alex Road and 13' north of a concrete entranceway to the shopping center. Elevation = 974.86'
BM "B":	Cross notch set on a light pole located in a parking lot neat the center of the site Elevation = 975.87'
BM "C":	Cross notch set on a hydrant located on the north side of the site, approximately 4 feet south of the curb along the south right-of-way line of Watertower Lane and 22' east of a 35 mph sign.

* HORIZONTAL DATUM: NAD 83

NOTE: REFER TO ALTA SURVEY, SHEET C1.1, FOR BENCHMARK LOCATIONS.

Elevation = 972.46'

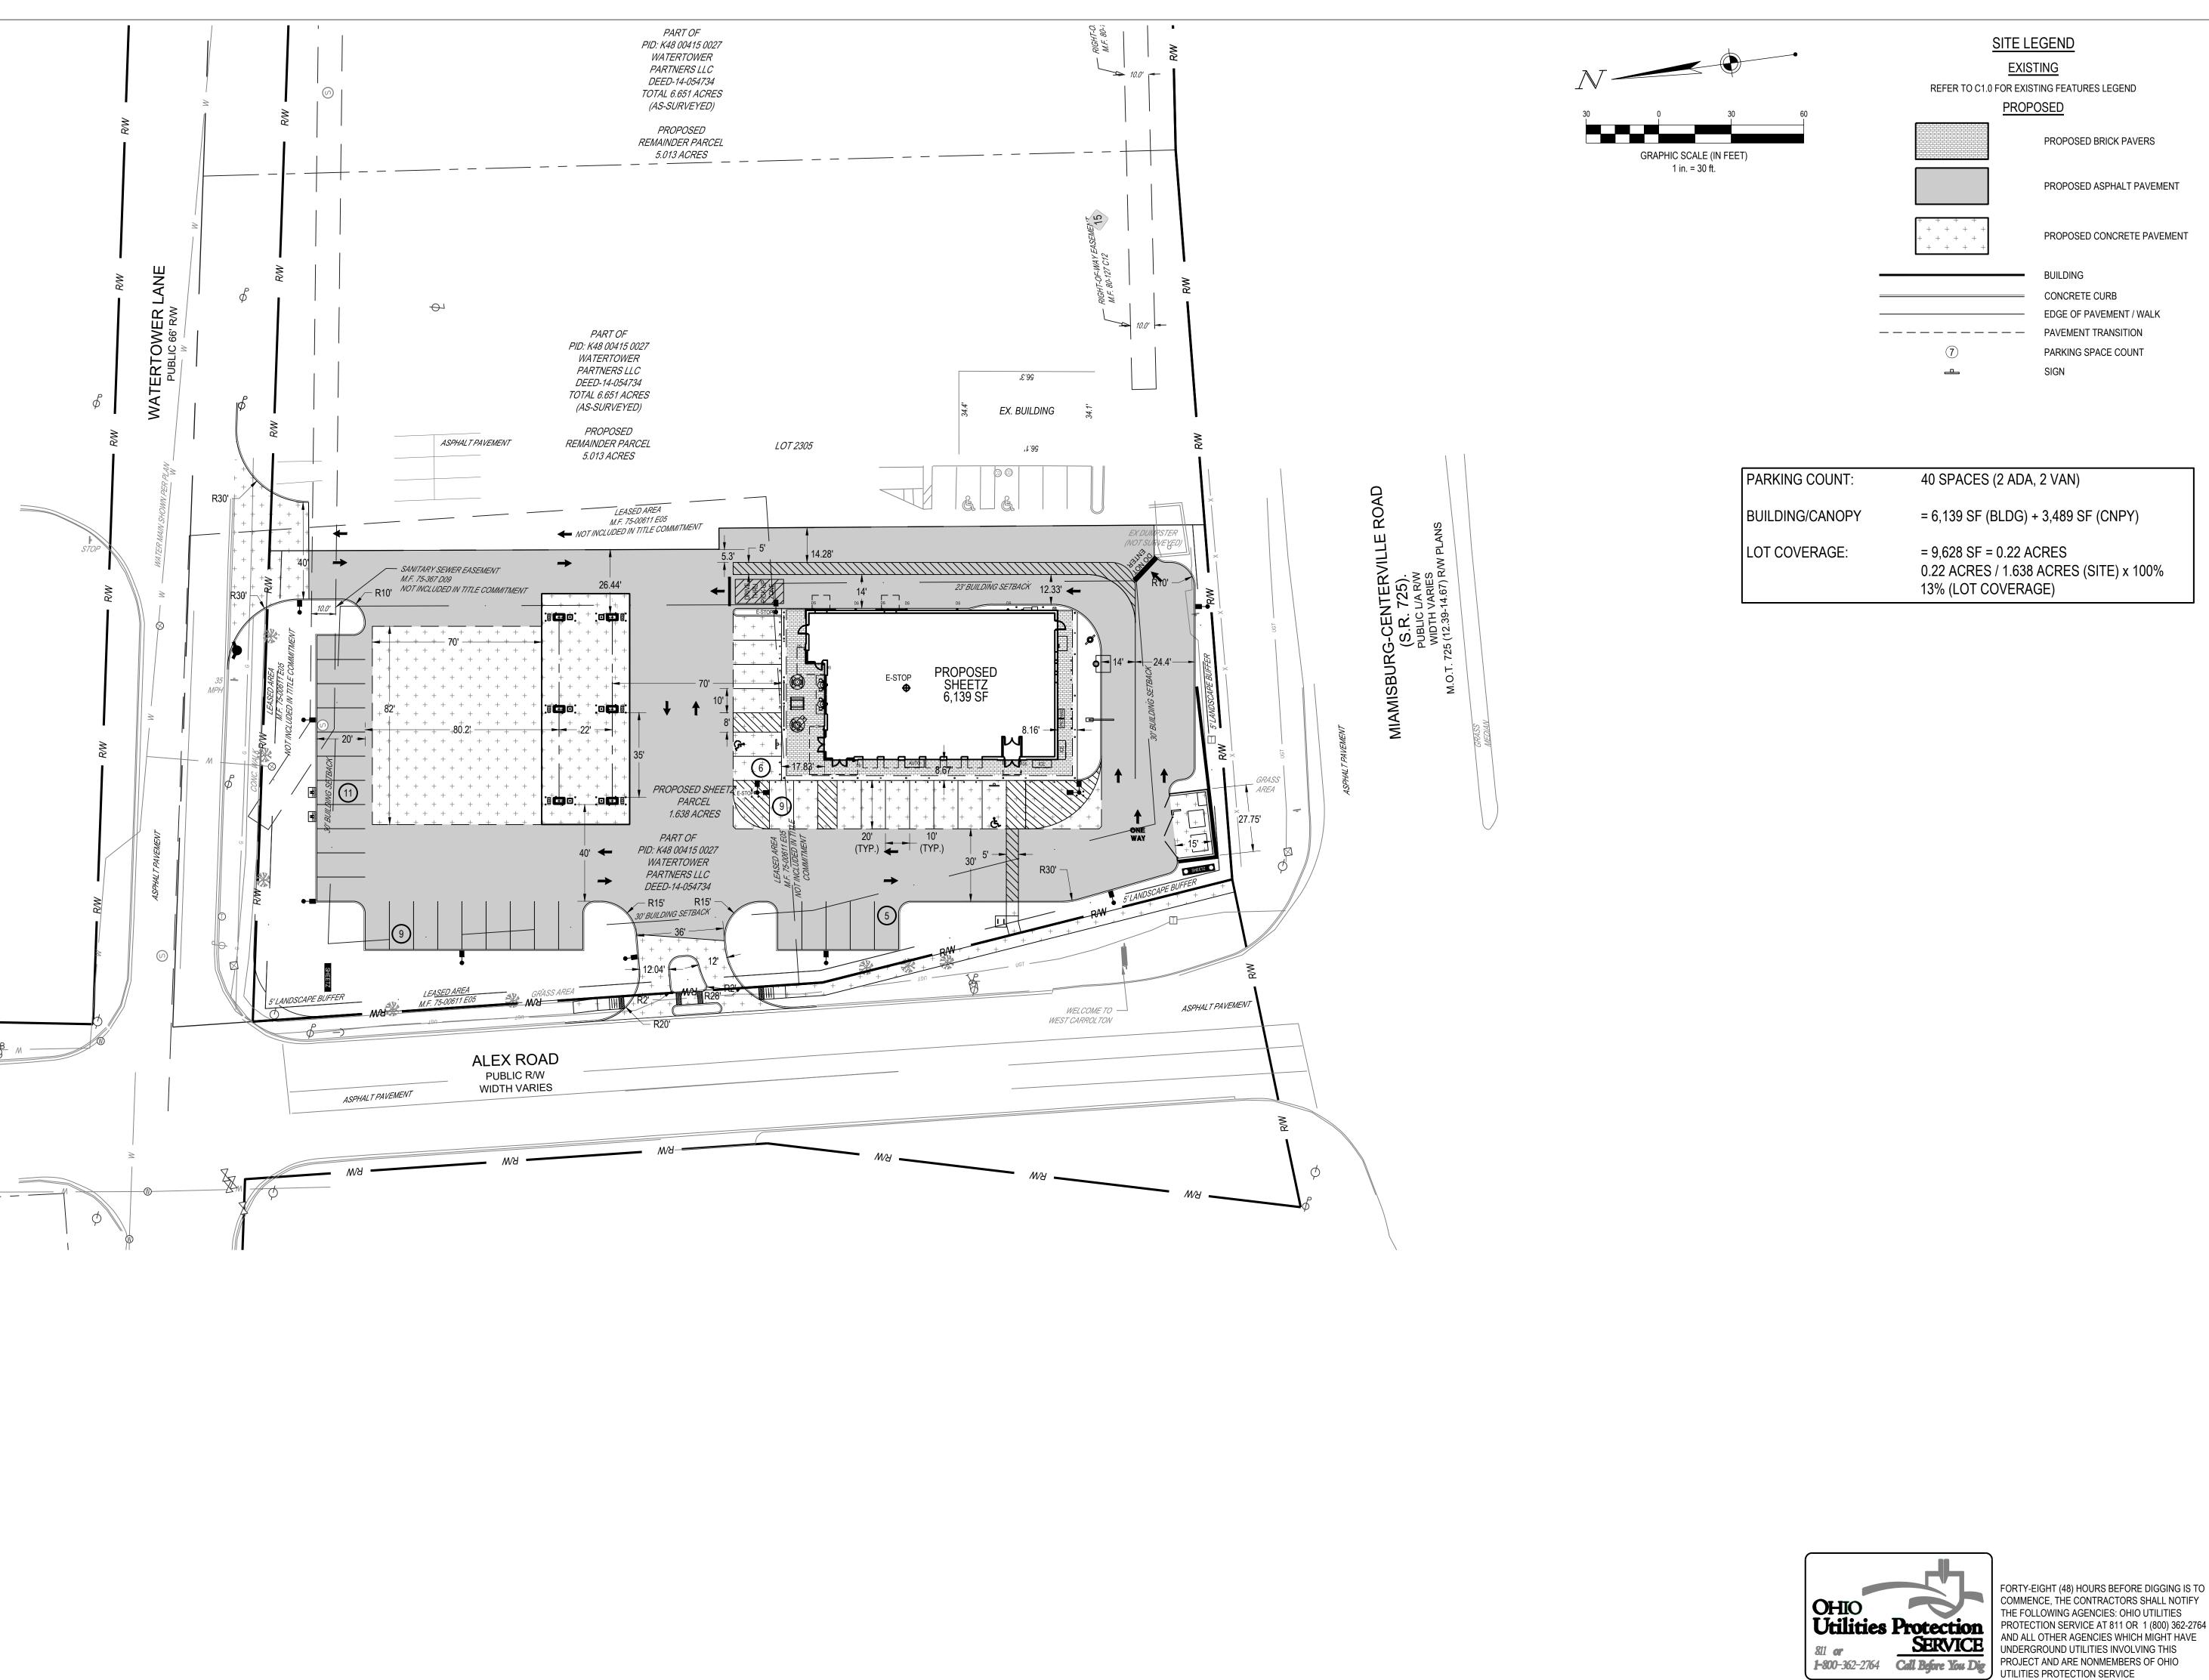



PROPOSED BRICK PAVERS

PROPOSED ASPHALT PAVEMENT

BUILDING CONCRETE CURB EDGE OF PAVEMENT / WALK PAVEMENT TRANSITION PARKING SPACE COUNT

= 6,139 SF (BLDG) + 3,489 SF (CNPY)

0.22 ACRES / 1.638 ACRES (SITE) x 100%



WWW.CESCINC.COM

2800 Corporate Exchange Dr., Suite 400 Columbus, OH 43231 Phone: 614.794.7080 Fax: 888.208.4826


ID Description

Project	Number:	763658
Scale:		AS SHOWN
Drawn	Ву:	CDR
Checke	ed By:	RAP
Date:		04.29.2024
lssue:	NOT FOR	CONSTRUCTION

Drawing Title:

SITE PLAN

C3.0

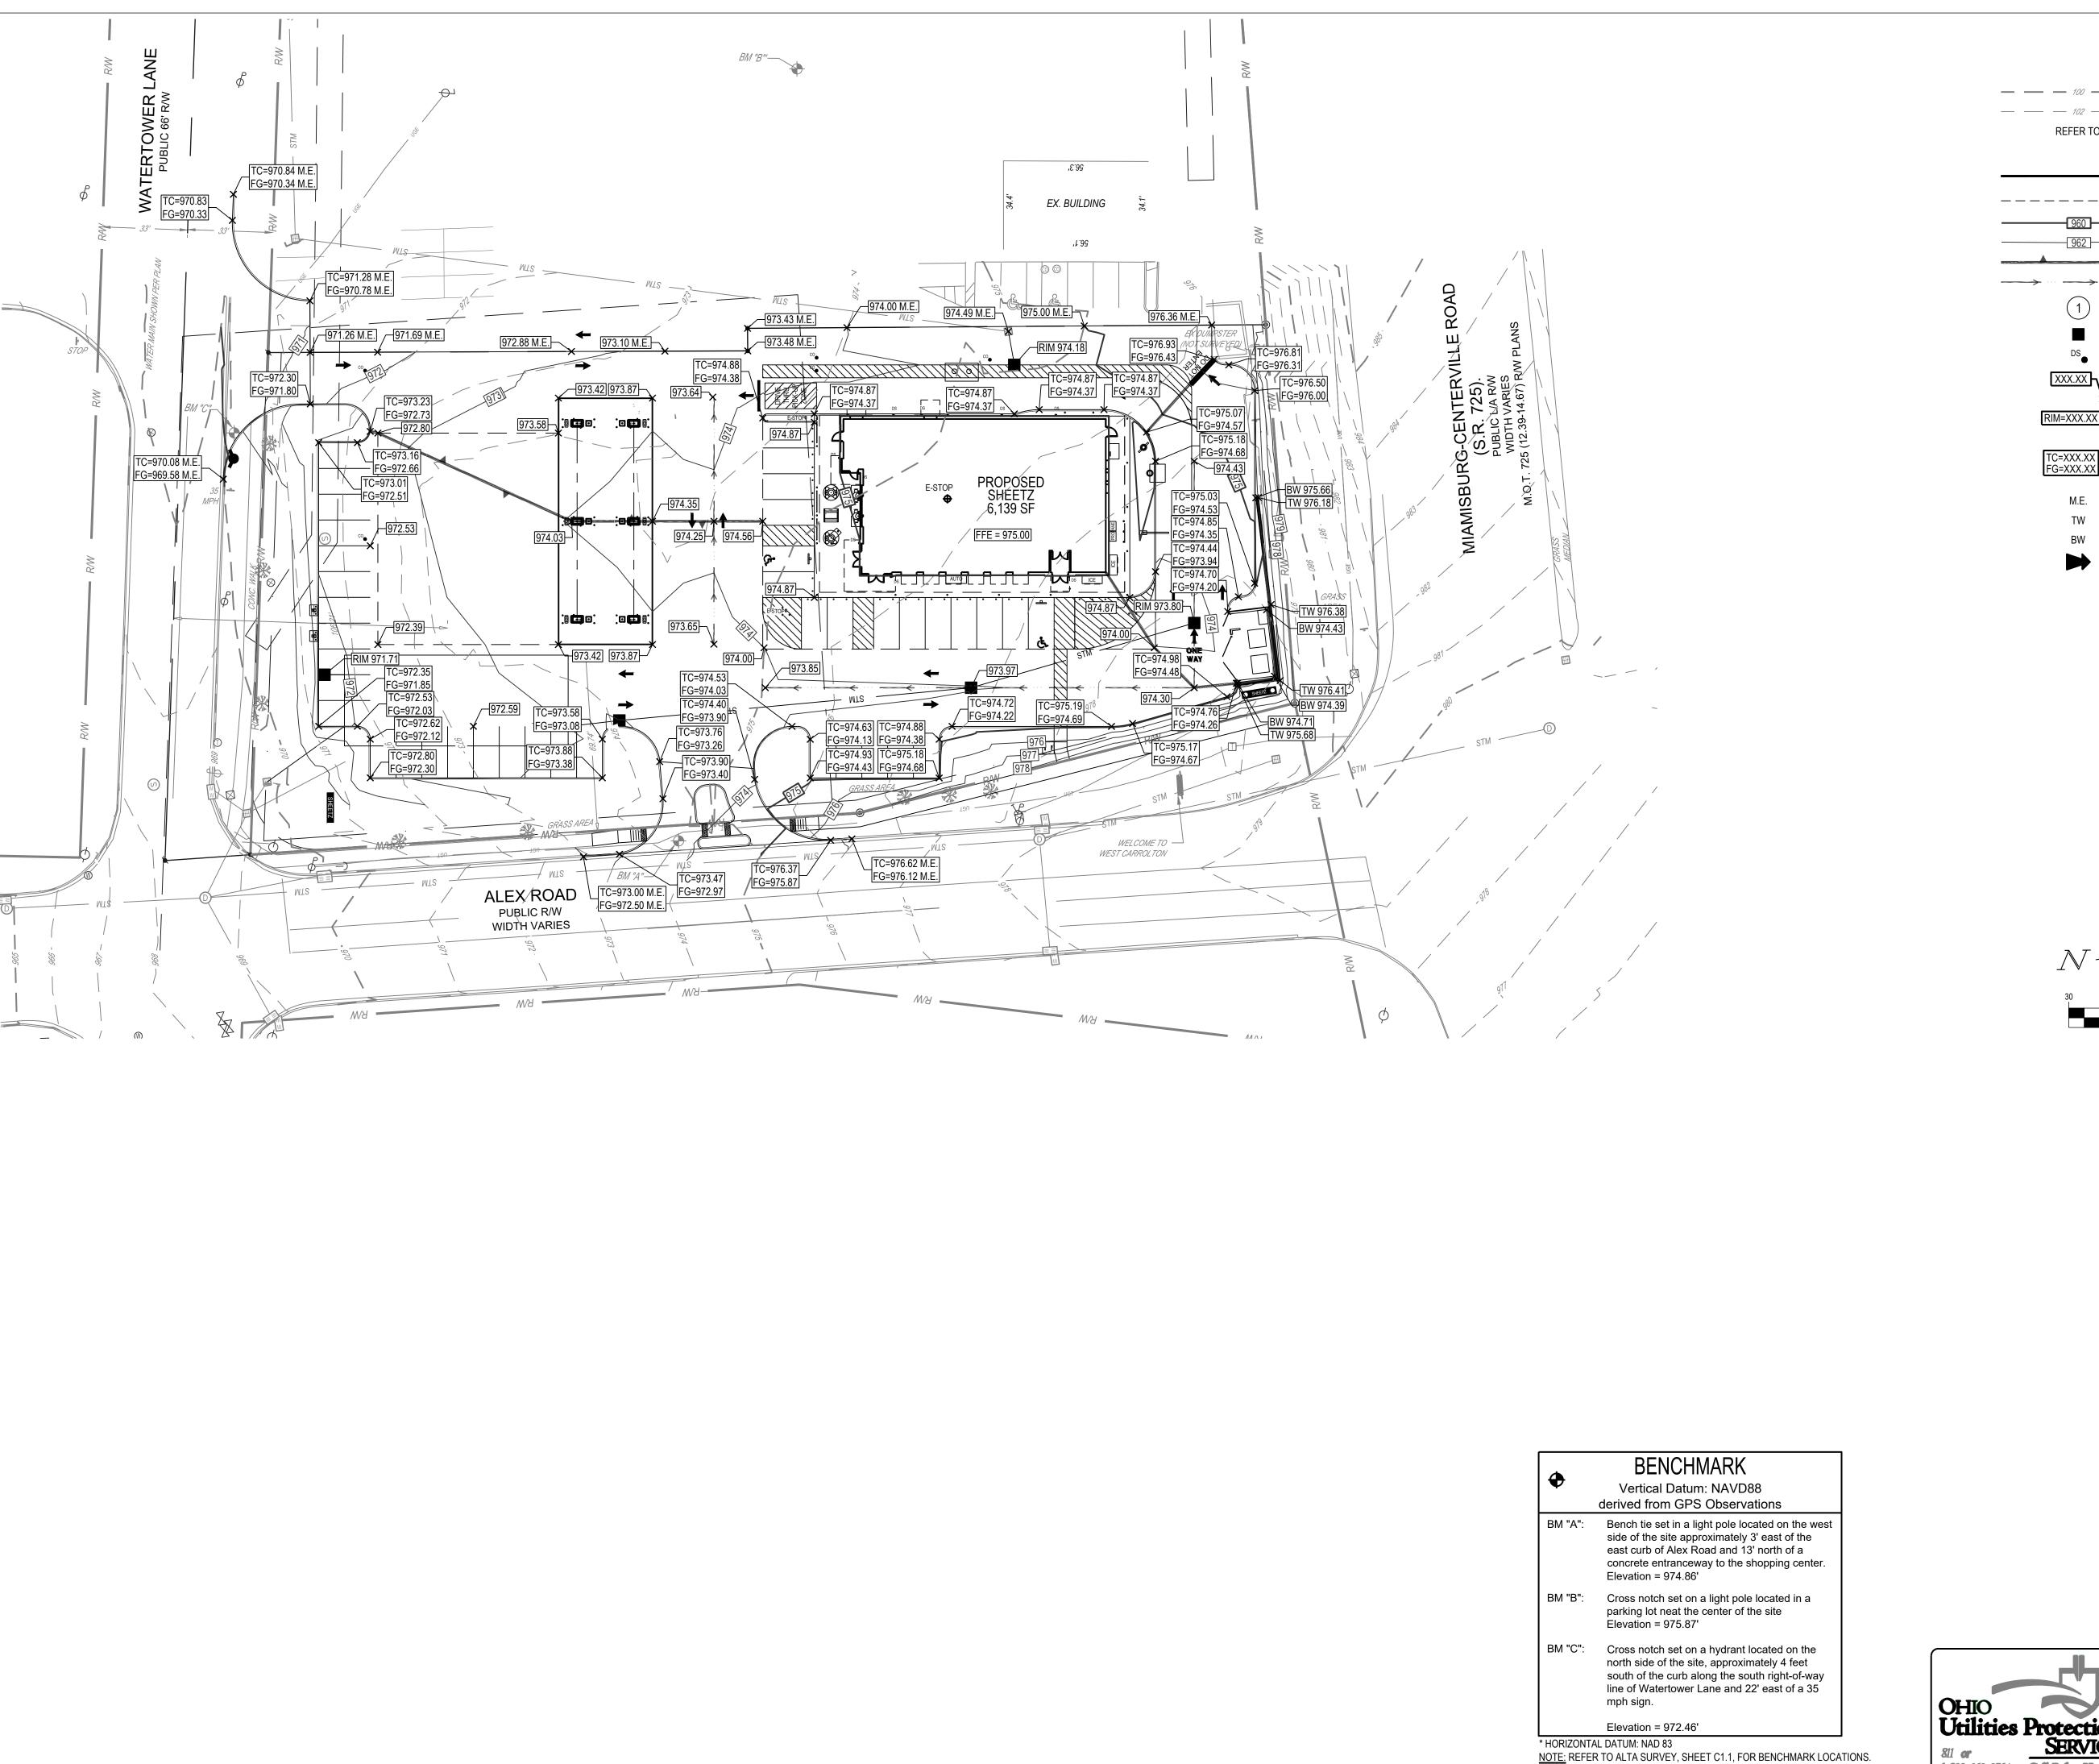



EXISTING

— — — 100 — — MAJOR CONTOUR — — — 102 — — MINOR CONTOUR

REFER TO C1.0 FOR EXISTING FEATURES LEGEND **PROPOSED**

	BUILDING
	PAVEMENT TRANSITION
960	MAJOR CONTOUR
962	MINOR CONTOUR
	GRADE BREAK
→ · · · → · · ·	SWALE LINE
1	SWALE LINE STORM STRUCTURE I.D.
	STORM STRUCTURE I.D.

TOP OF CURB ELEVATION

FINISHED GRADE ELEVATION RIM ELEVATION

FINISHED GRADE ELEVATION MATCH EXISTING ELEVATION TOP OF WALL ELEVATION BOTTOM OF WALL ELEVATION FLOOD ROUTE

> GRAPHIC SCALE (IN FEET) 1 in. = 30 ft.

AND ALL OTHER AGENCIES WHICH MIGHT HAVE

UTILITIES PROTECTION SERVICE



605

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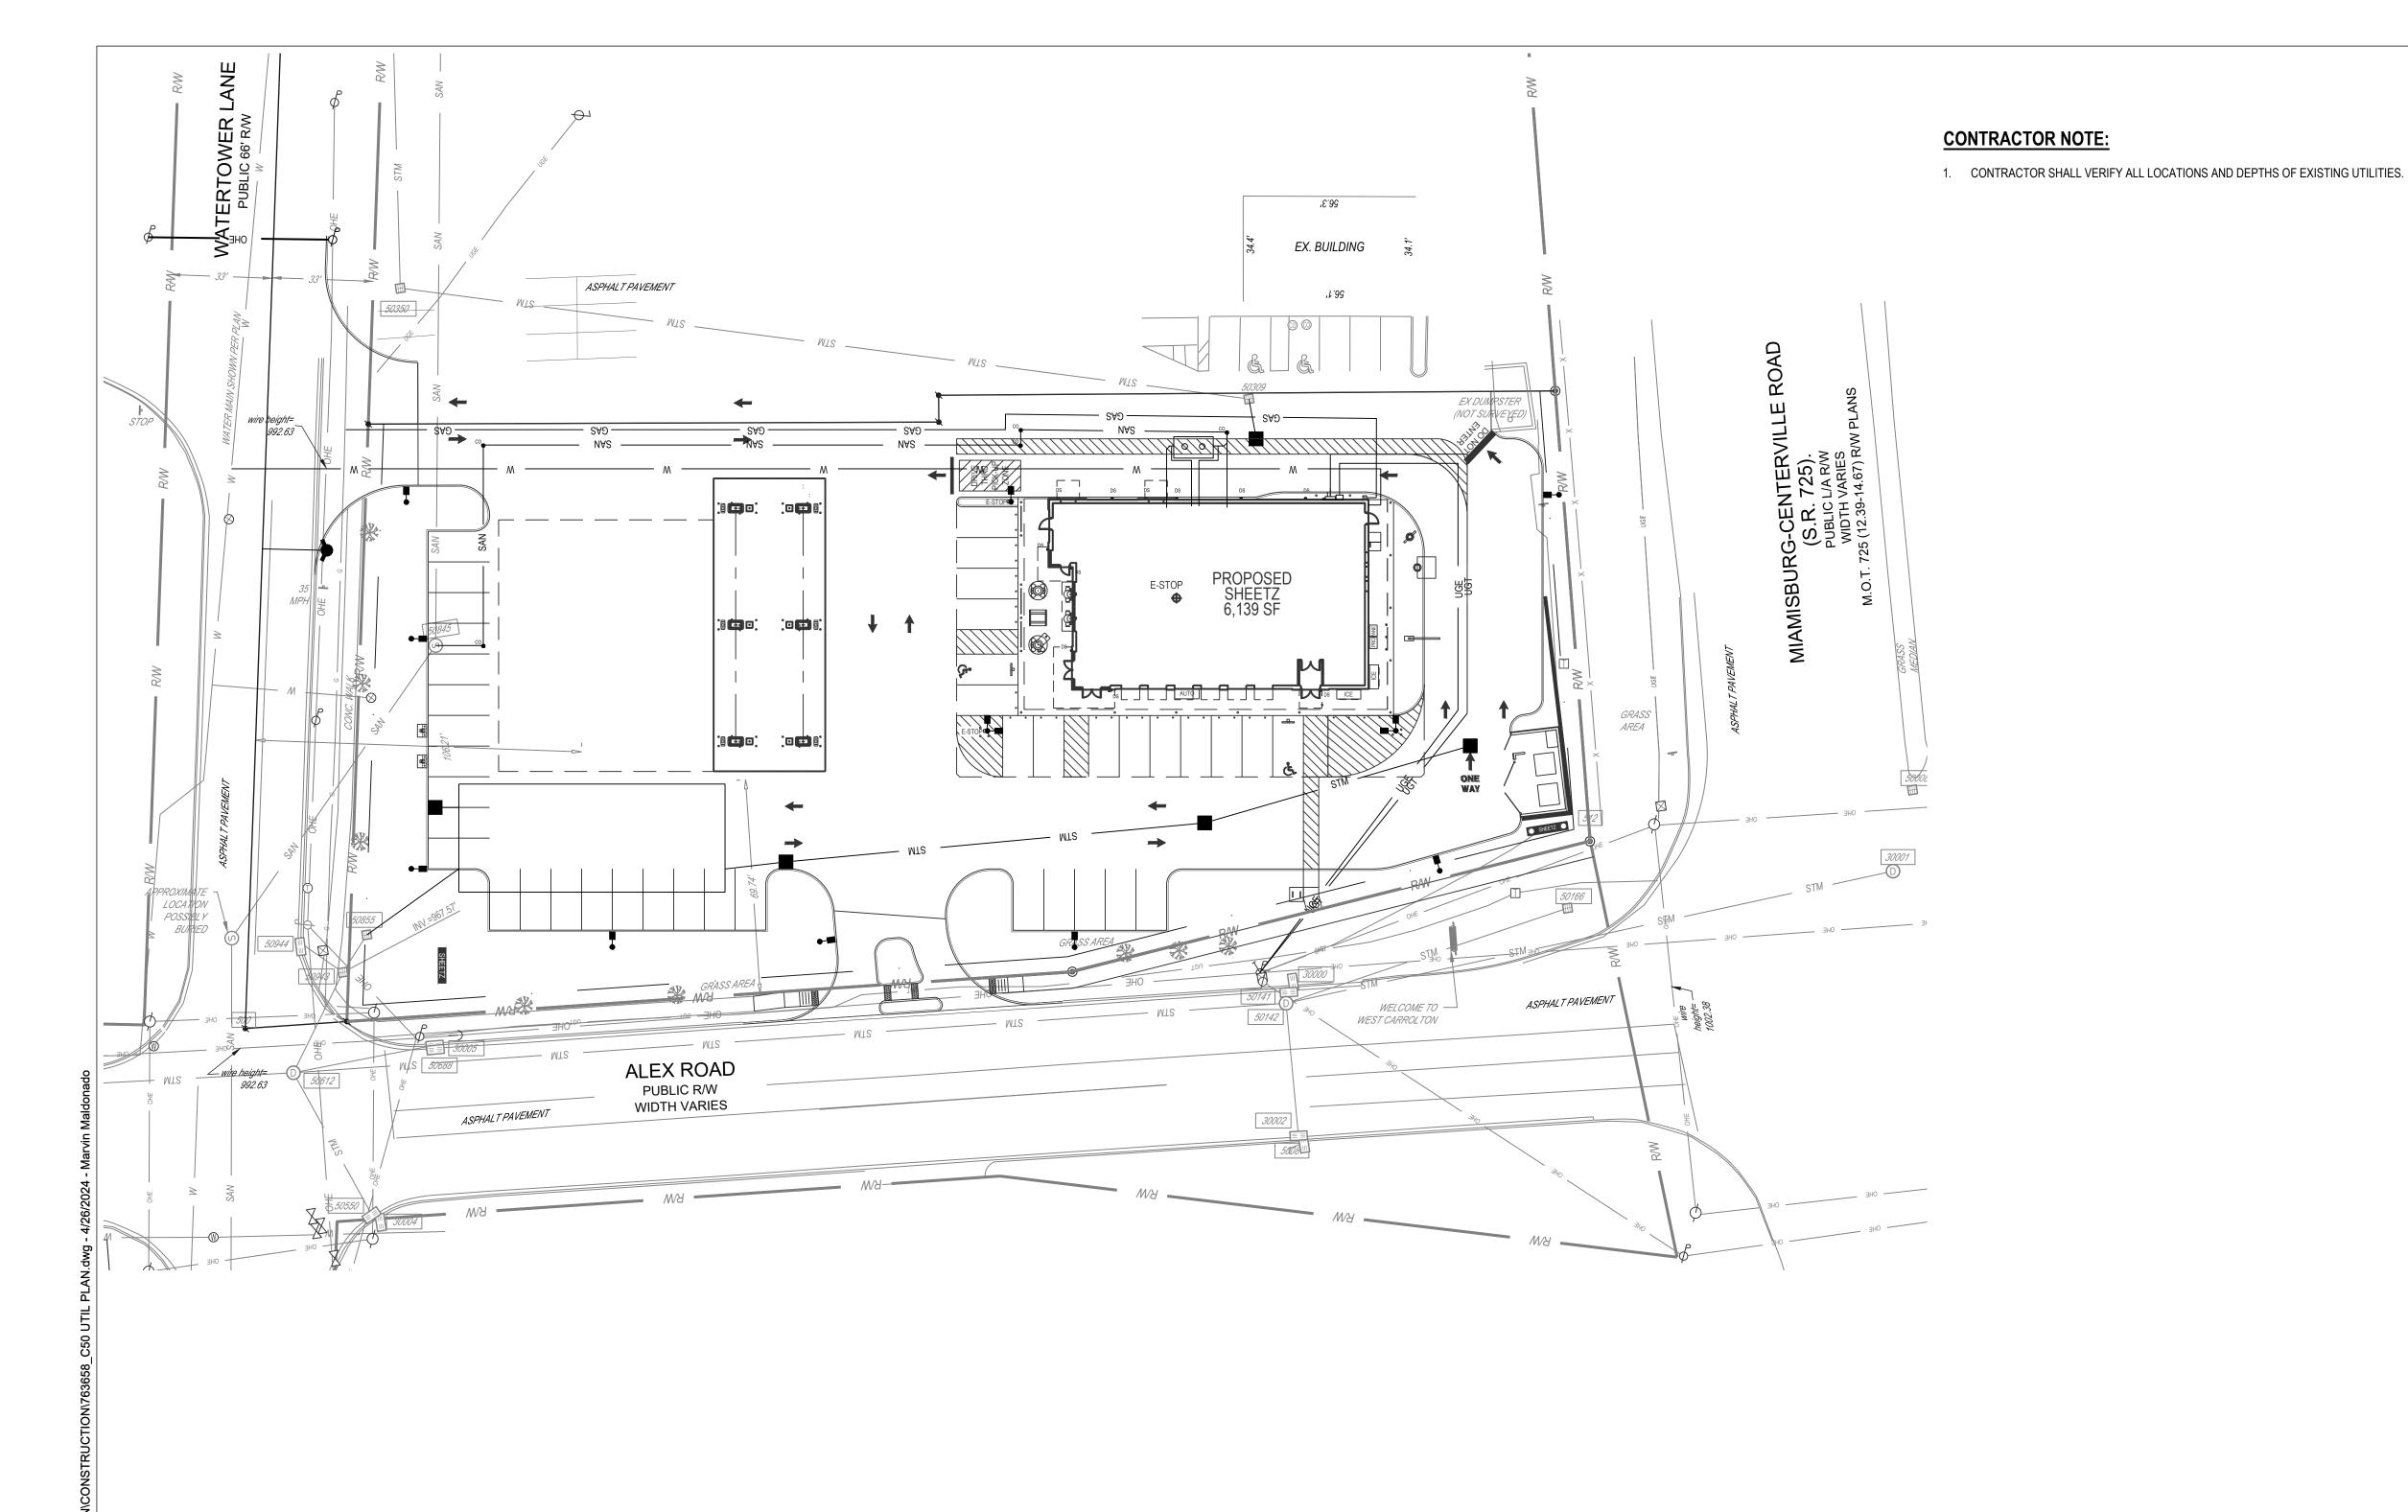
763658 **Project Number:** 1" = 20' Scale: CDR Drawn By: Checked By: 04.29.2024 Date: Issue: NOT FOR CONSTRUCTION

Drawing Title:

GRADING PLAN

C4.0

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EXISTING

REFER TO C1.0 FOR EXISTING FEATURES LEGEND

UTILITY LEGEND

PROPOSED

-	DOILDING
	SEE ENLARGED PLAN, THIS SHEET
STM	STORM SEWER LINE
DS	STORM DOWNSPOUT LINE
SAN	SANITARY SEWER LINE
— w —	DOMESTIC WATER LINE
	IRRIGATION SLEEVES
G	GAS SERVICE LINE
UGE	UNDERGROUND ELECTRIC LINE
UGT	UNDERGROUND TELEPHONE LINE
	CATCH BASIN
0	STORM SEWER MANHOLE
<u>\$</u>	SANITARY SEWER MANHOLE
co	CLEANOUT
DS	DOWNSPOUT
TPAD	ELECTRICAL TRANSFORMER PAD
	FIRE HYDRANT
•	WATER VALVE
wid	WATER SERVICE METER
G	GAS METER
A	SANITARY STRUCTURE I.D.
1	STORM STRUCTURE I.D.






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Drawing Title:
UTILITY PLAN


C5.0



FORTY-EIGHT (48) HOURS BEFORE DIGGING IS TO COMMENCE, THE CONTRACTORS SHALL NOTIFY THE FOLLOWING AGENCIES: OHIO UTILITIES PROTECTION SERVICE AT 811 OR 1 (800) 362-2764 AND ALL OTHER AGENCIES WHICH MIGHT HAVE UNDERGROUND UTILITIES INVOLVING THIS PROJECT AND ARE NONMEMBERS OF OHIO UTILITIES PROTECTION SERVICE

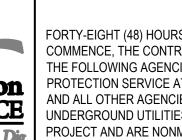

GRAPHIC SCALE (IN FEET) 1 in. = 30 ft.

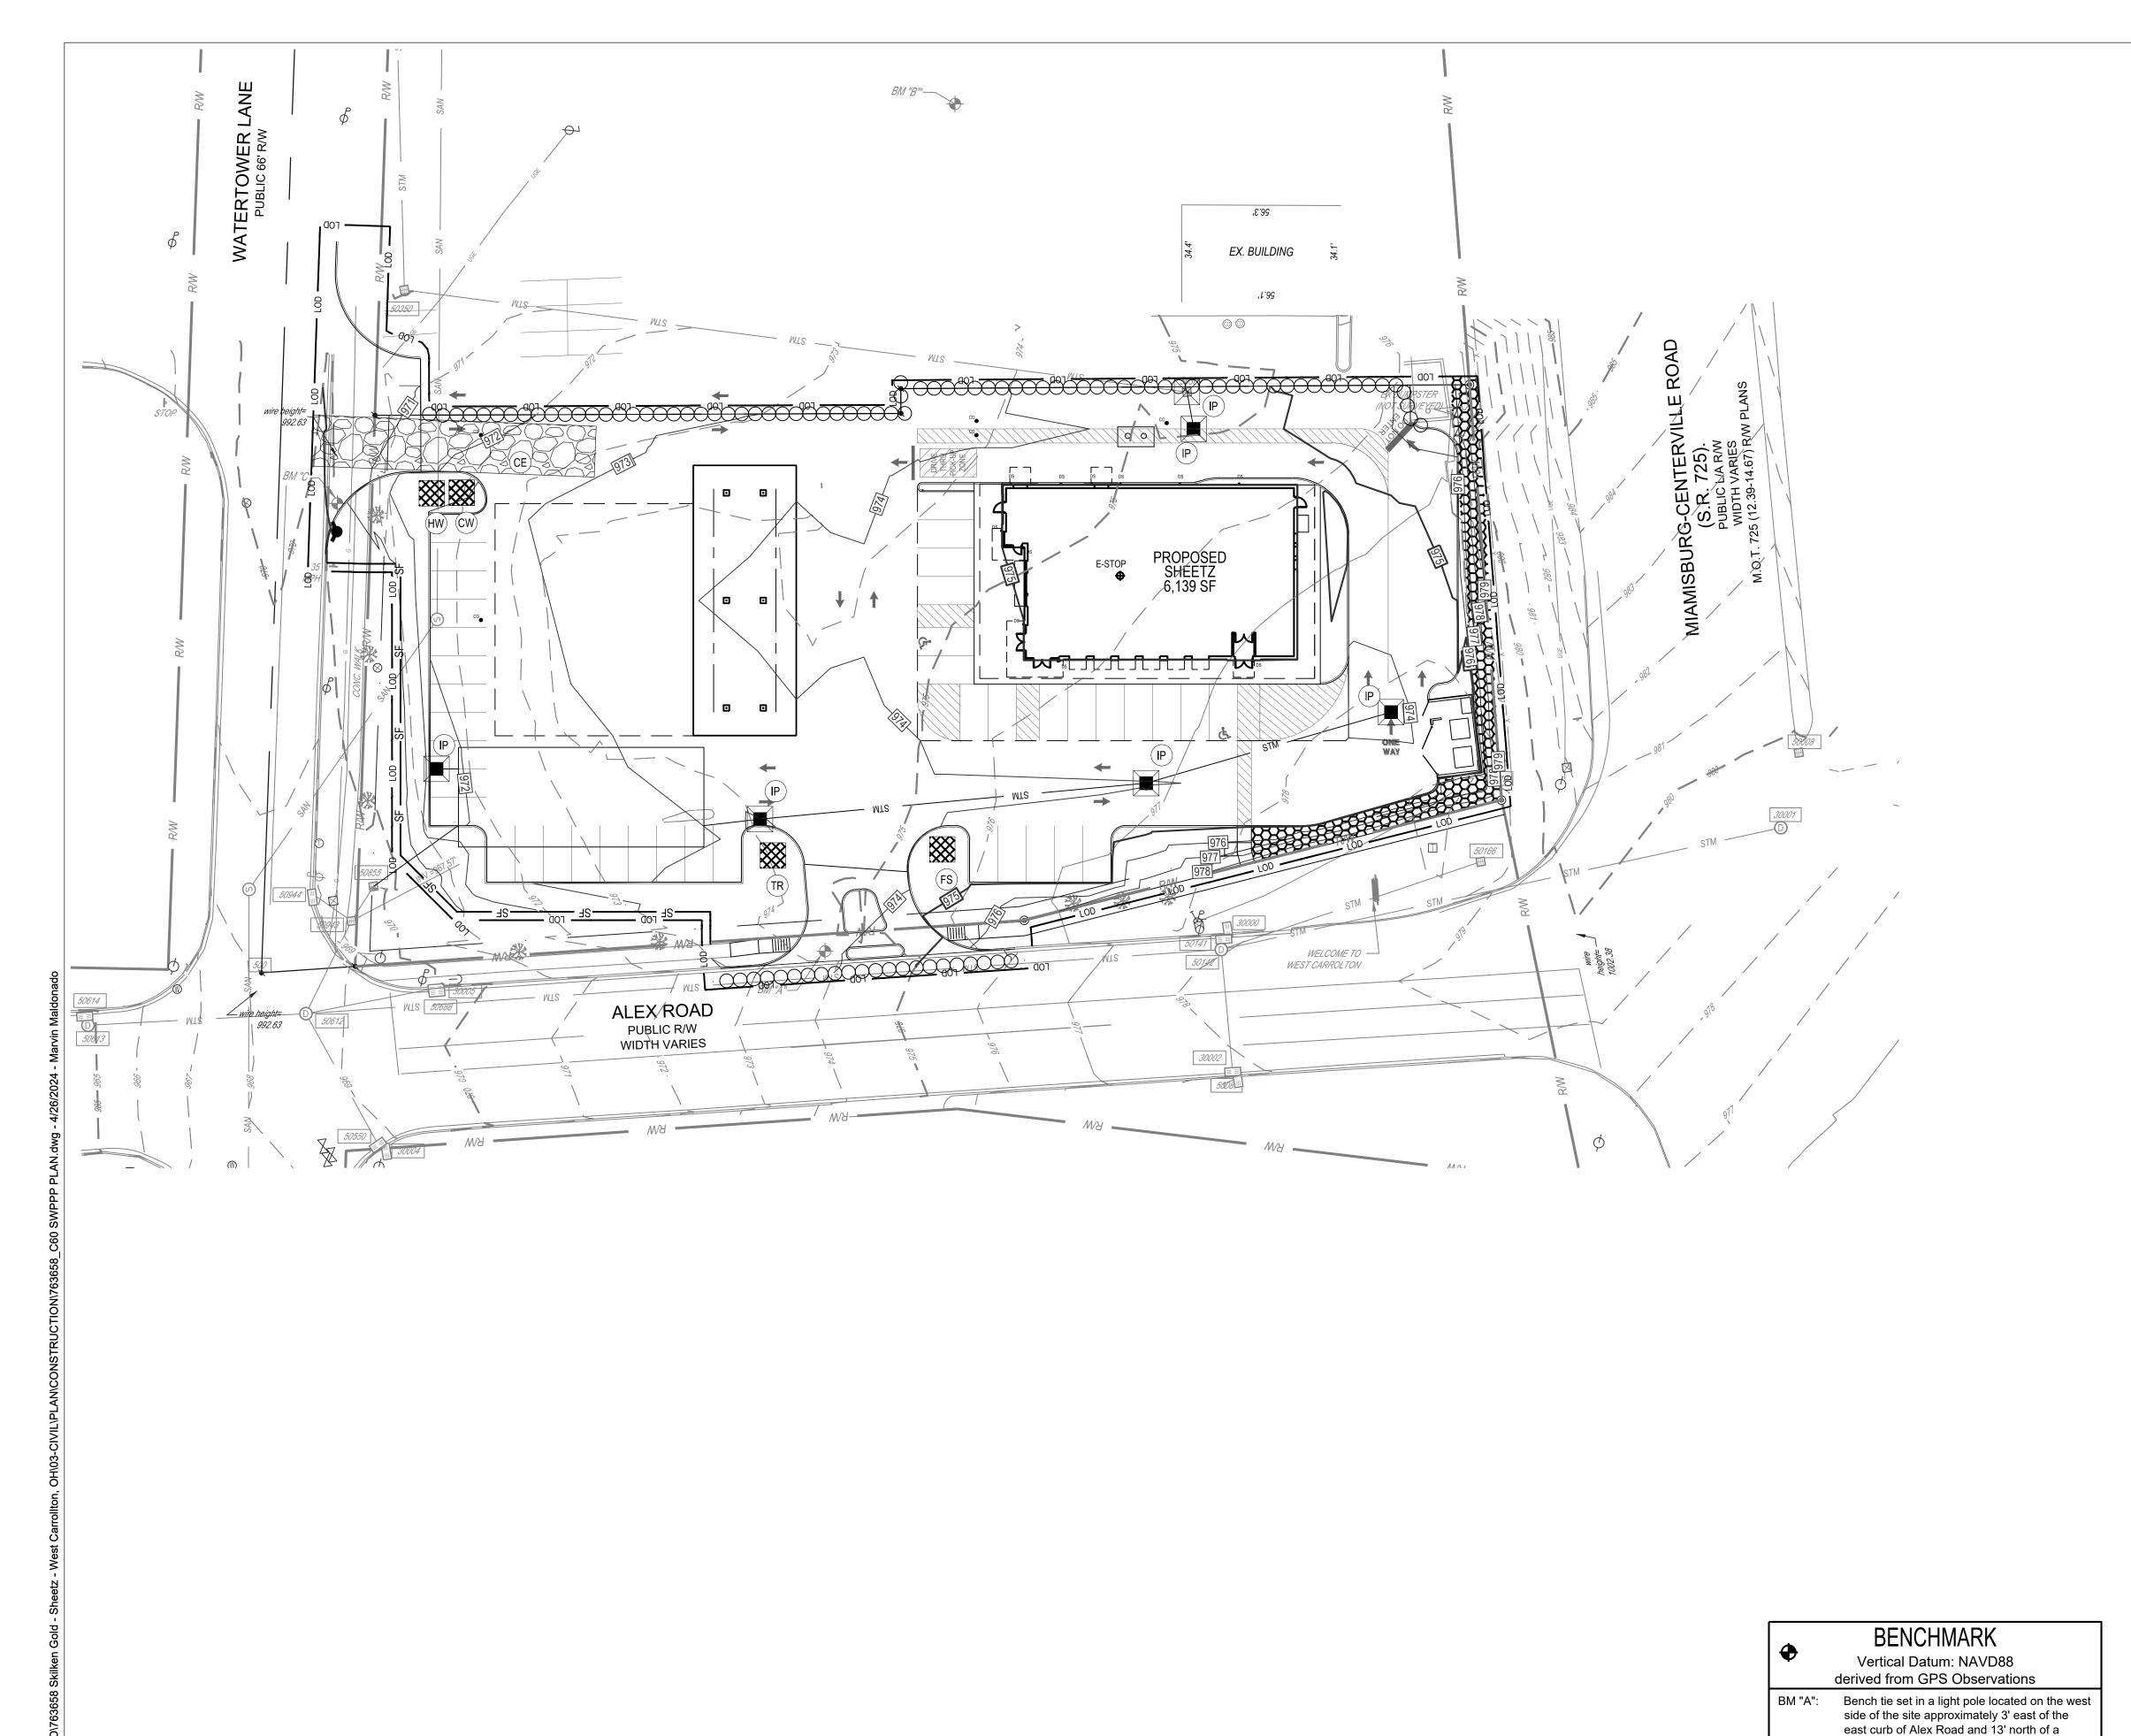

SWPPP LEGEND

FXISTI


— — — 100 — — — MAJOR CONTOUR
— — — 102 — — — MINOR CONTOUR

REFER TO C1.0 FOR EXISTING FEATURES LEGEND

PROPOSEI

960 MAJOR CONTOUR
962 MINOR CONTOUR
PAVEMENT/WALK
STM STORM SEWER

SF —— SF —— SILT FENCE
STRAW WATTLE
LIMITS OF DISTURBANCE

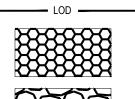

STEEPER STABILIZED CONSTRUCTION

PERMANENT EROSION CONTROL BLANKET ON ALL 3:1 SLOPES OR

STABILIZED OF ENTRANCE

CONCRETE V
AREA

CONCRETE WASHOUT / STORAGE
AREA
CATCH BASIN
STABILIZED CONSTRUCTION

CONCRETE WASHOUT AREA

INLET PROTECTION

ENTRANCE

TEMPORARY SEEDING
PS)
PERMANENT SOD

HZ) STORAGE AREA FOR HAZARDOUS MATERIALS

STORAGE AREA FOR FUEL

STORAGE AREA FOR TRASH

OWNER/DEVELOPER: SKILKEN GOLD REAL ESTATE DEVELOPMENT 4270 MORSE POAD

4270 MORSE ROAD
COLUMBUS, OH 43230
PHONE: (614) 935-0217
CONTACT: AJ SCOTT
EMAIL: ASCOTT@skilkengold.com

ENGINEER: CESO, INC.

2800 CORPORATE EXCHANGE DR, SUITE 400 COLUMBUS, OH 43231 PHONE: (380) 799-5227 CONTACT: JOSH LONG EMAIL: JOSH.LONG@CESOINC.COM

STORMWATER POLLUTION PREVENTION PLAN (SWPPP) PROJECT NARRATIVE:

THE PROPOSED PROJECT IS THE CONSTRUCTION OF A RESTAURANT / CONVENIENCE STORE WITH FUELING STATION. THE SUBJECT PARCEL IS 1.64 ACRES. THE TOTAL DISTURBED AREA IS 1.65 ACRES.

EXISTING RUNOFF CONDITIONS: FLOWS INTO PUBLIC STORM SYSTEM OFF WATERTOWER LANE

PROPOSED RUNOFF CONDITIONS: FLOWS INTO PUBLIC STORM SYSTEM OFF WATERTOWER LANE

ON-SITE SOILS: CeA - CELINA SILT LOAM, 0 TO 2 PERCENT SLOPES 38.4%
MIB2 - MIAMIAN SILT LOAM, 2 TO 6 PERCENT SLOPES 55.5%
MnC3 - MIAMIAN CLAY LOAM, 6 TO 12 PERCENT SLOPES 0.3%
Ud - UDORTHENTS 5.8%

HYDROLOGIC SOIL GROUPS: CeA - C/D MIB2 - C MnC3 - C

SEQUENCE OF CONSTRUCTION

UNLESS NOTED OTHERWISE, THE GENERAL CONTRACTOR IS RESPONSIBLE FOR MAINTAINING ALL EROSION AND SEDIMENT CONTROL MEASURES IN STRICT ACCORDANCE WITH THE SWPPP THROUGHOUT THE DURATION OF THE PROJECT

- 1. ENSURE NOTICE OF INTENT (N.O.I.) IS FILED, KEEP A COPY OF THE PERMIT ONSITE. NOTIFY ALL APPROPRIATE PARTIES, INCLUDING THE MONTGOMERY COUNTY ENGINEER, BEFORE WORK IS TO BEGIN.
- 2. INSTALL TEMPORARY EROSION CONTROL MEASURES INCLUDING CONSTRUCTION ENTRANCE, FILTER SOCKS, SILT FENCE, SEDIMENT TRAPS, ETC. AS DEPICTED IN THE PHASE 1 PLAN.
- 3. INSPECTION OF EROSION CONTROL MEASURES AS OUTLINED IN NOTES. REPAIRS AND / OR REPLACEMENTS
- SHALL BE MADE NECESSARY.

 4. BEGIN SITE DEMOLITION / CLEARING.
- 5. BEGIN ROUGH GRADING. PROVIDE TEMPORARY SEEDING OF DISTURBED AREAS WHICH ARE INACTIVE.
- 6. INSTALL REMAINING E&S CONTROLS.
- 7. STORM SEWER AND UNDERGROUND UTILITY CONSTRUCTION.
- 8. BUILDING PAD.

concrete entranceway to the shopping center.

Elevation = 974.86'

Elevation = 975.87'

Elevation = 972.46'

mph sign.

* HORIZONTAL DATUM: NAD 83

BM "B": Cross notch set on a light pole located in a

BM "C": Cross notch set on a hydrant located on the


parking lot neat the center of the site

north side of the site, approximately 4 feet south of the curb along the south right-of-way

NOTE: REFER TO ALTA SURVEY, SHEET C1.1, FOR BENCHMARK LOCATIONS.

line of Watertower Lane and 22' east of a 35

- 9. CURB CONSTRUCTION.
- 10. FINE GRADING AND PAVEMENT SUB-GRADE PREPARATION
- 11. ASPHALT PAVING AND REMAINING CONCRETE FLATWORK.
- 12. FINAL SEEDING AND STABILIZATION.

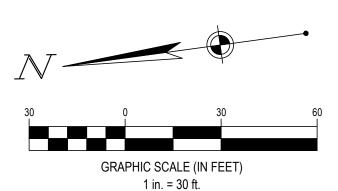



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HEETZ-EST CARROLLTON,

Revisions / Submissions

Date

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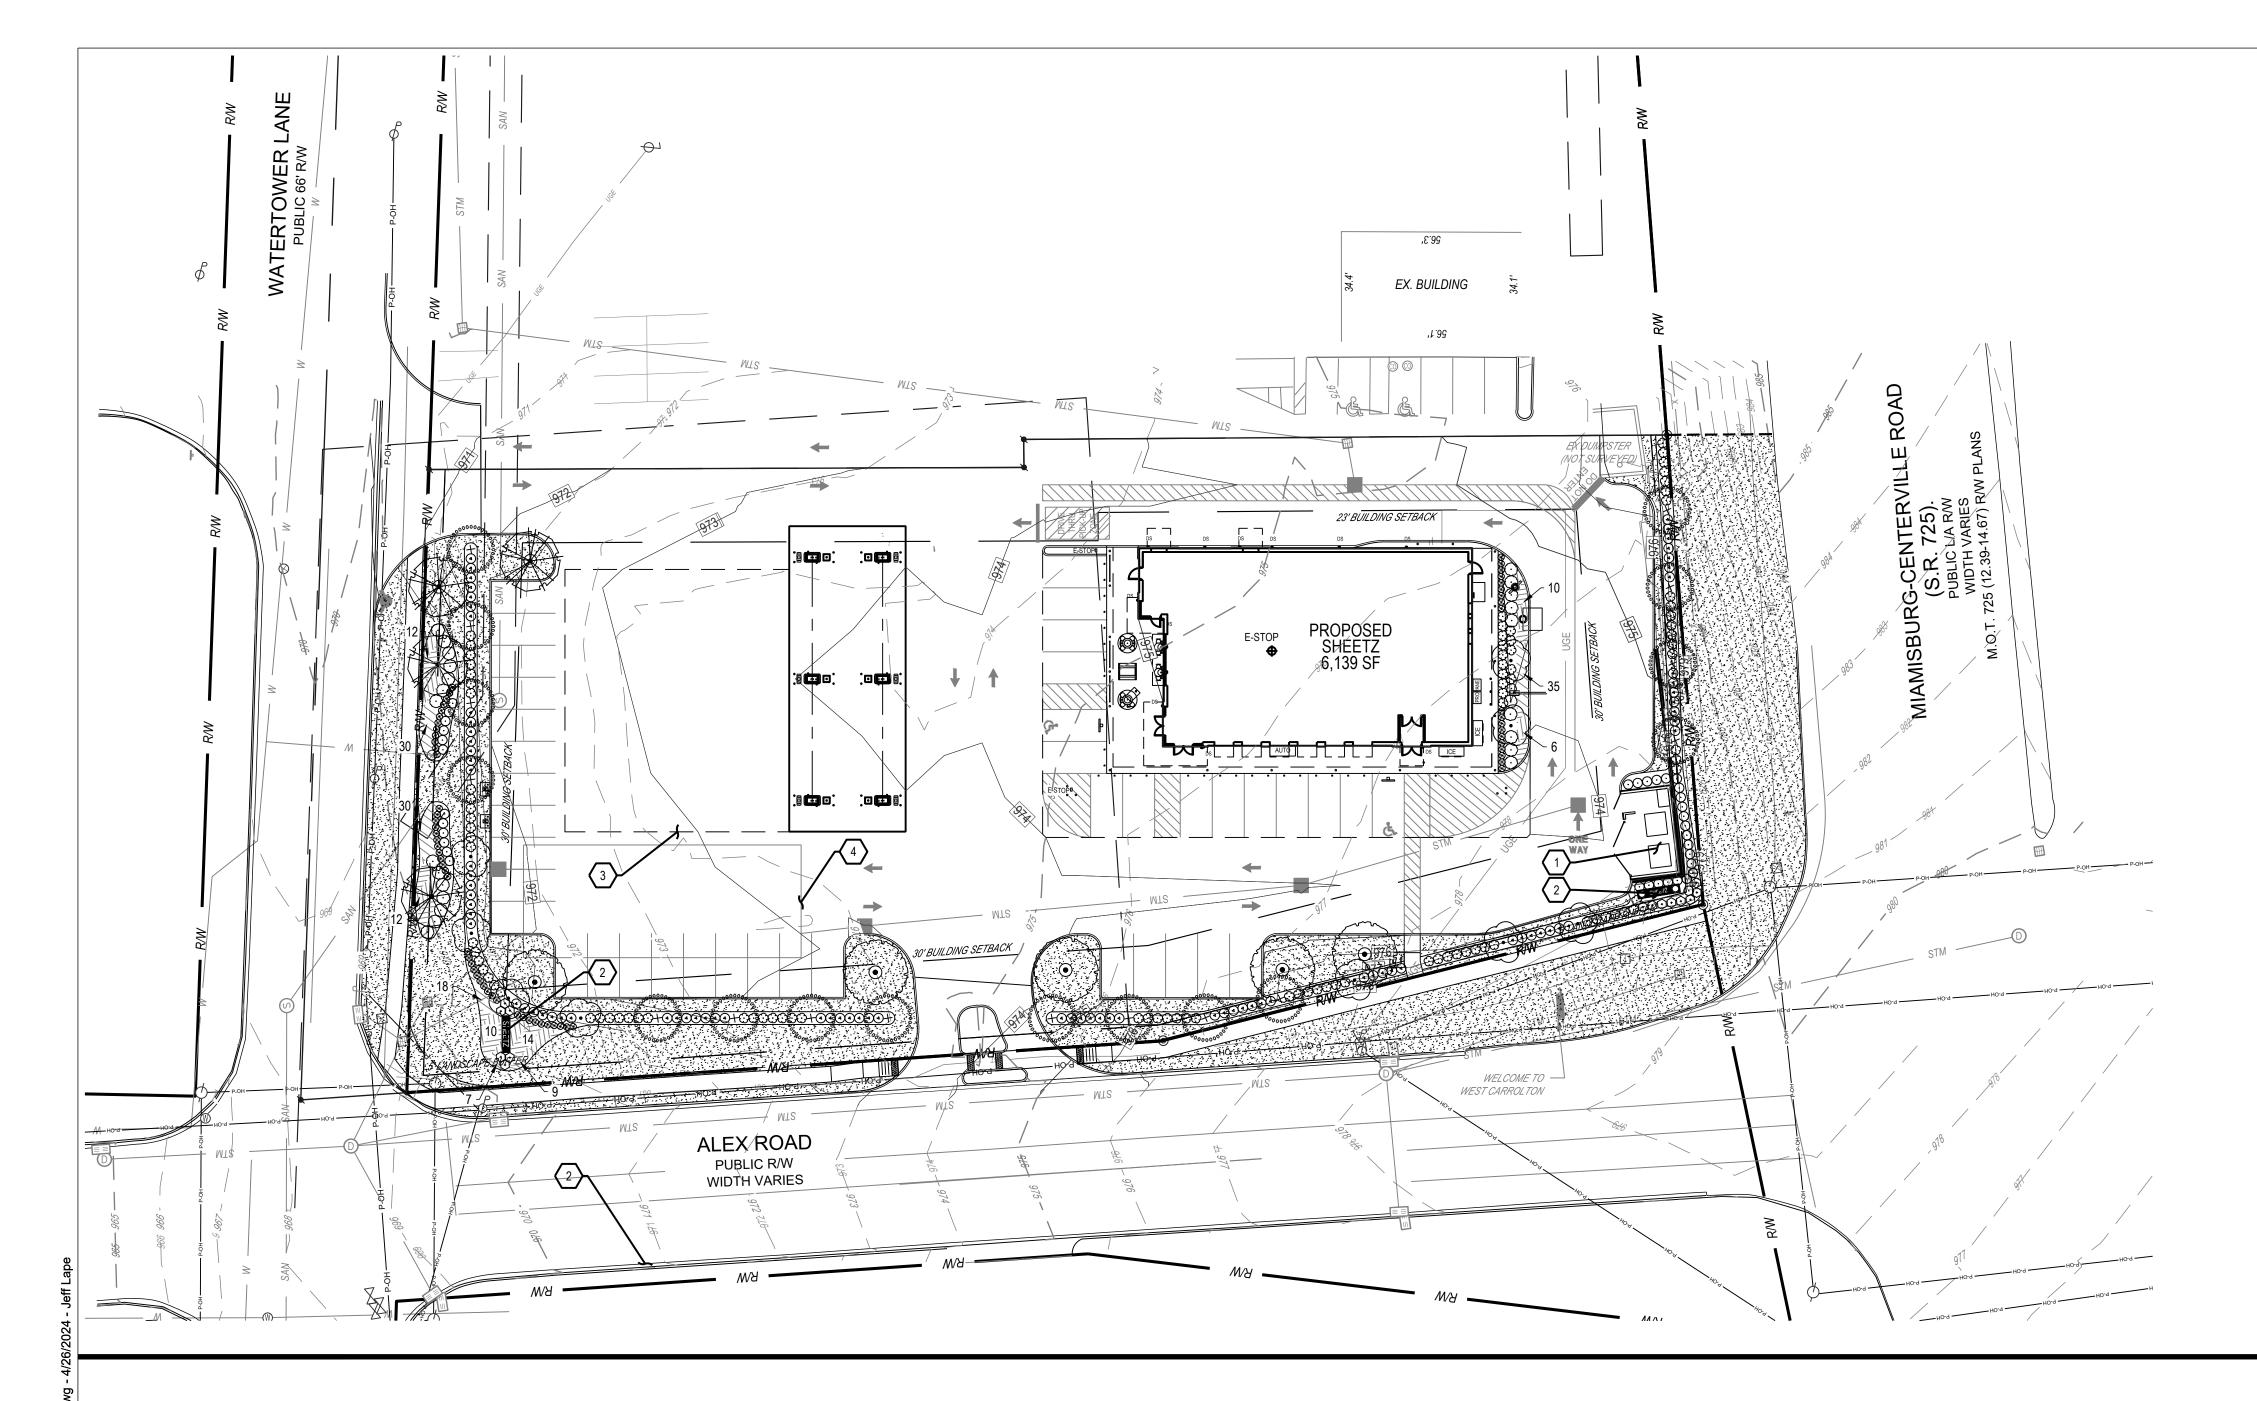
Project Number: 763658
Scale: AS SHOWN
Drawn By: CDR
Checked By: RAP

Issue: NOT FOR CONSTRUCTION

Drawing Title:

SWPPP

C6.0





LEGEND	
	RIGHT OF WAY LINE
	LOT LINE
	PROPERTY BOUNDARY LINE
	EASEMENT LINE
	SIGHT TRIANGLE LINE PROPOSED CONCRETE SIDEWALK OR DECK
P-OH P-OH	OVERHEAD POWER LINE
STM	STORM DRAIN
SAN	SANITARY SEWER
W	WATER LINE
G	GAS LINE
UGT	UNDERGROUND TELEPHONE LIN
UGE	UNDERGROUND ELECTRIC LINE
	SOD LIMIT
	MAJOR EXISTING CONTOUR
	MINOR EXISTING CONTOUR
	MAJOR ENGINEERED CONTOUR
	MINOR ENGINEERED CONTOUR

CODED NOTES:

- 1. PROPOSED TRASH ENCLOSURE
- 2. PROPOSED MONUMENT SIGNAGE
- 3. PROPOSED UNDERGROUND FUEL TANK PAD AND VENT PAD
- 4. PROPOSED STORMWATER DETENTION VAULT

SYMBOL	QTY	BOTANICAL / COMMON NAME	SIZE	MIN HT / SPR	SPACING
TREES					
+ ***	16	CORNUS KOUSA KOUSA DOGWOOD	1.5" CAL	8-10` HT	AS SHOWN
	9	NYSSA SYLVATICA TUPELO	2" CAL	10-12` HT	AS SHOWN
	9	PRUNUS SUBHIRTELLA 'AUTUMNALIS' AUTUMN FLOWERING CHERRY	1.5" CAL	8-10` HT	AS SHOWN
0	35	THUJA OCCIDENTALIS 'YELLOW RIBBON' YELLOW RIBBON ARBORVITAE		6` HT	3'-0" OC
SHRUBS					
•	82	ABELIA X 'EDWARD GOUCHER' EDWARD GOUCHER ABELIA CALAMAGROSTIS X ACUTIFLORA 'KARL		24-36" HT	3,-0, OC
⊛	78	FOERSTER'		24" HT	2`-0" OC
\odot	28	KARL FOERSTER FEATHER REED GRASS CORNUS SERICEA 'FARROW' ARCTIC FIRE® RED TWIG DOGWOOD		24" HT	4`-0" OC
②	14	CRYPTOMERIA JAPONICA 'GLOBOSA NANA' DWARF JAPANESE CEDAR		24" HT	3`-0" OC
9	81	ILEX GLABRA 'SHAMROCK' SHAMROCK INKBERRY HOLLY		24" HT	3`-0" OC

1 GAL

3 GAL

SOD

1`-6" OC

3`-0" OC

SHAMROCK INKBERRY HOLLY

HYPERICUM ADPRESSUM

KENTUCKY BLUEGRASS

POA PRATENSIS

CREEPING ST. JOHNSWORT

BLUE PACIFIC SHORE JUNIPER

- NUMBER INDICATED ON HATCH THROUGHOUT THE DRAWING REFLECTS THE NUMBER OF PLANTS IN THAT PARTICULAR AREA

JUNIPERUS CONFERTA 'BLUE PACIFIC'

PLANT SCHEDULE

GROUND COVERS

18,951 SF

MULCH

- ALL PLANT BEDS SHALL CONTAIN A 3" LAYER OF DOUBLE HAMMERED HARDWOOD MULCH CONTRACTOR TO PLACE 4' DIAMETER MULCH RING AROUND ALL TREES IN LAWN
- LANDSCAPE ISLANDS ADJACENT TO THE TANK MAP AND BUILDING SHALL CONTAIN STONE MULCH, 1-3" JACKS, LOCALLY
- SOURCED AND INSTALLED OVER A WEED BARRIER

LANDSCAPE REQUIREMENTS

VEHICULAR USE AREAS (SEC 154.13.01.G)

PERIMETER LANDSCAPING - 5' PERIMETER SCREENING WITH EITHER 1 SHADE TREE @ 30' OC AND SHRUBS @ 3' OC OR 1 ACCENT TREE @ 25' OC AND SHRUBS 3' OC

REQUIRED PERIMETER LANDSCAPING: 22 ACCENT TREES, 163 SHRUBS (555 LF)

PROVIDED PERIMETER LANDSCAPING: 22 ACCENT TREES, 163 SHRUBS

INTERIOR LANDSCAPE AREA - 5% OF THE TOTAL AREA DEVOTED TO PARKING SPACE AND LANES SHALL BE LANDSCAPED AND PERMEABLE

REQUIRED INTERIOR LANDSCAPE AREA: 2,470 SF (49,392 SF * 5%) PROVIDED INTERIOR LANDSCAPE AREA: 2,735 SF

MINIMUM TREE SPECIFICATIONS - 2 TREES SHALL BE PROVIDED FOR EVERY 5,000 SF OF TOTAL GROUND COVERED BY STRUCTURES AND PAVEMENT

REQUIRED TREES: 12 TREES (58,727 SF / 5000)


CONSTRAINTS)

PROVIDED TREES: 12 TREES (1 PROVIDED IN PERIMETER LANDSCAPING DUE TO SITE

LANDSCAPING REQUIREMENTS MATRIX (SEC 154.13.01.I)

PLANTING ALONG RIGHT-OF-WAY (FRONT YARD) - 10% OF TOTAL REQUIRED FRONT YARD AREA MUST BE LANDSCAPED WITH A COMBINATION OF TREES, SHRUBS, PLANTIING BEDS AND/OR PERENNALS

REQUIRED FRONT YARD LANDSCAPING: 1,212 SF (12,118 SF * 10%) PROVIDED FRONT YARD LANDSCAPING: 1,260 SF

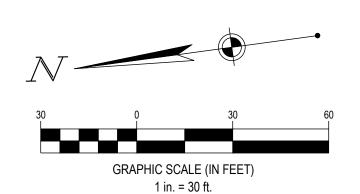



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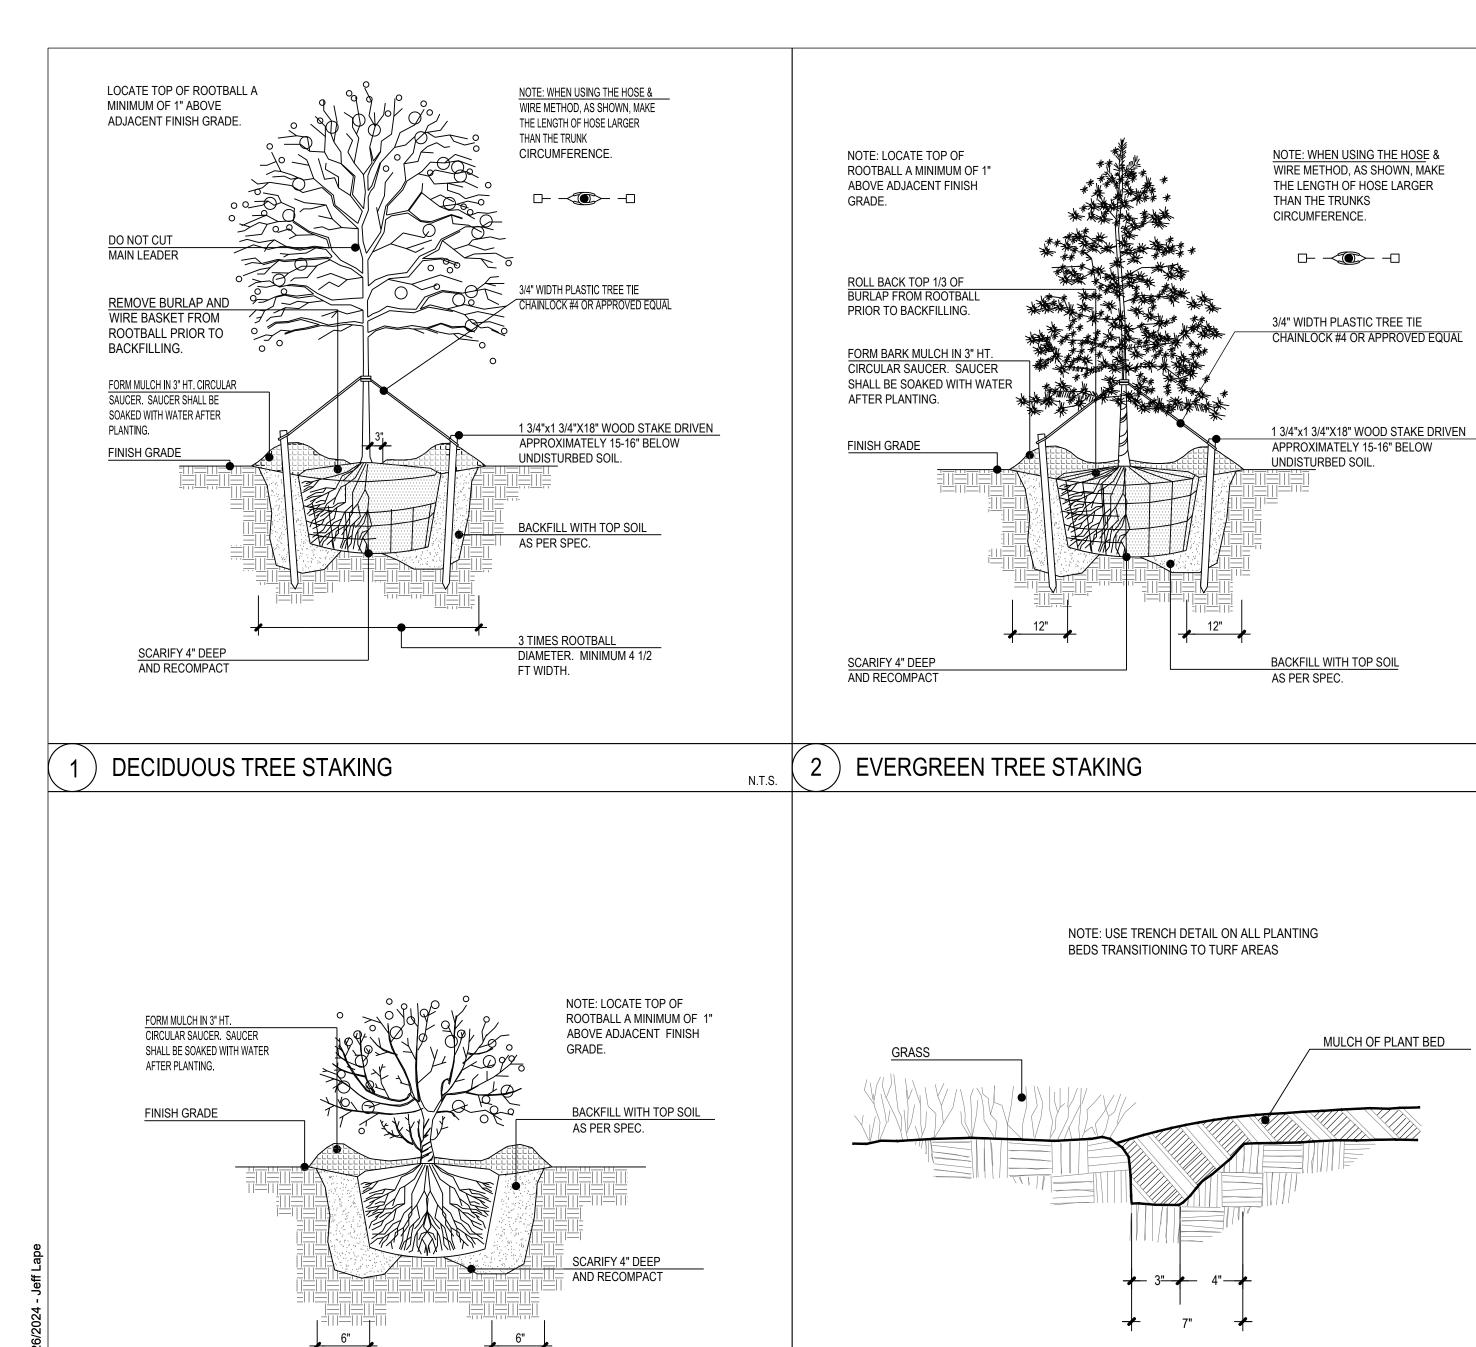


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Revisions / Submissions ID Description Date


763658 Project Number: AS SHOWN Drawn By: Checked By: 04.29.2024 Issue: NOT FOR CONSTRUCTION

Drawing Title: LANDSCAPE PLAN



EVERGREEN / DECIDUOUS SHRUB

TRENCH EDGING

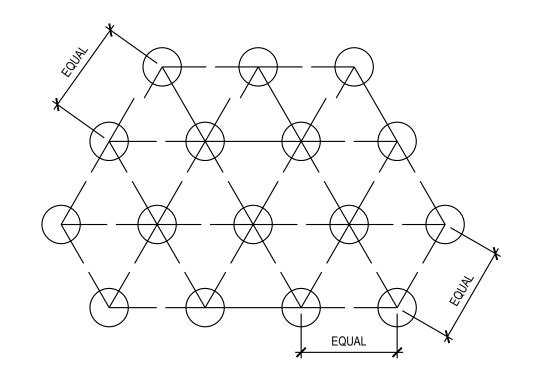

ALL GROUND COVER SHALL BE PLANTED AT EQUAL TRIANGULAR SPACING PER ON CENTER SPACING AS SPECIFIED ON PLANTING PLAN.

LOCATE GROUND COVER ONE HALF OF SPECIFIED SPACING DISTANCE FROM ANY CURB, SIDEWALK, OR OTHER HARD SURFACE, UNLESS OTHERWISE NOTED.

GROUND COVER SPACING

GENERAL NOTES: LANDSCAPE PLAN

- CONTRACTOR TO VERIFY WITH OWNER AND UTILITY COMPANIES THE LOCATIONS OF ALL UTILITIES PRIOR TO CONSTRUCTION, TO DETERMINE IN THE FIELD THE ACTUAL LOCATIONS AND ELEVATIONS OF ALL EXISTING UTILITIES, WHETHER SHOWN ON THE PLANS OR NOT. THE CONTRACTOR SHALL CALL UTILITY LOCATE SERVICE 72 HOURS PRIOF TO CONSTRUCTION.
- 2. SITE CONDITIONS BASED UPON SURVEY PROVIDED BY OWNER. CONTRACTOR TO FIELD VERIFY EXISTING CONDITIONS BY DETAILED INSPECTION PRIOR TO SUBMITTING BID AND BEGINNING CONSTRUCTION.
- 3. REFER TO SITE CIVIL DRAWINGS FOR ADDITIONAL REQUIREMENTS AND COORDINATE WORK WITH OTHER SITE RELATED DEVELOPMENT DRAWING AS NEEDED.
- 4. REESTABLISH EXISTING TURF IN AREAS DISTURBED BY GRADING OR UTILITY TRENCHING, INCLUDING AREAS IN RIGHT-OF-WAY, TO MATCH EXISTING SPECIES.
- 5. CONTRACTOR SHALL EXAMINE FINISH SURFACE, GRADES, TOPSOIL QUALITY AND DEPTH. DO NOT START ANY WORK UNTIL UNSATISFACTORY CONDITIONS HAVE BEEN CORRECTED. VERIFY LIMITS OF WORK BEFORE STARTING.
- 6. CONTRACTOR TO REPORT ALL DAMAGES TO EXISTING CONDITIONS AND INCONSISTENCIES WITH PLANS TO LANDSCAPE ARCHITECT.
- 7. CONTRACTOR SHALL MAINTAIN POSITIVE DRAINAGE IN ALL LANDSCAPE BEDS AND ALL LAWN AREAS.
- 8. CONTRACTOR TO FINE GRADE AND ROCK-HOUND ALL TURF AREAS PRIOR TO SEEDING, TO PROVIDE A SMOOTH AND CONTINUAL SURFACE, FREE OF IRREGULARITIES (BUMPS OR DEPRESSIONS) & EXTRANEOUS MATERIAL OR DEBRIS.
- 9. REMOVE EXISTING WEEDS FROM PROJECT SITE PRIOR TO THE ADDITION OF ORGANIC AMENDMENTS AND FERTILIZER APPLY AMENDMENTS AND FERTILIZER AS NEEDED.
- 10. QUANTITIES SHOWN ARE INTENDED TO ASSIST CONTRACTOR IN EVALUATING THEIR OWN TAKE OFFS AND ARE NOT GUARANTEED AS ACCURATE REPRESENTATIONS OF REQUIRED MATERIALS. THE CONTRACTOR SHALL BE RESPONSIBLE FOR HIS BID QUANTITIES AS REQUIRED BY THE PLANS AND SPECIFICATIONS. IF THERE IS A DISCREPANCY BETWEEN THE NUMBER LABELED ON THE PLANT LEGEND AND THE QUANTITY OF GRAPHIC SYMBOLS SHOWN, THE GREATER QUANTITY SHALL GOVERN.
- 11. COORDINATE LANDSCAPE INSTALLATION WITH INSTALLATION OF UNDERGROUND SPRINKLER AND DRAINAGE SYSTEMS.
- 12. ALL SIZES AND QUALITY OF PLANT MATERIAL SHALL MEET THE MINIMUM SPECIFICATIONS OF THE AMERICAN STANDARD FOR NURSERY STOCK (ANSI Z60.1-2014). THE LANDSCAPE CONTRACTOR SHALL INSTALL ALL PLANT MATERIAL IN SIZE AS INDICATED IN THE PLANT SCHEDULE UNLESS OTHERWISE SPECIFIED ON THE PLAN SET. ALL PLANTS THAT DO NOT MEET THE SIZE AND SPECIFICATIONS SET FORTH BY THE AMERICAN STANDARD FOR NURSER STOCK WILL BE REJECTED BY LANDSCAPE ARCHITECT AT NO COST TO OWNER.
- 13. ONCE PROJECT IS AWARDED, THE LANDSCAPE CONTRACTOR SHALL BE RESPONSIBLE TO SECURE ALL PLANT MATERIAL IN THE SIZE SPECIFIED ON PLAN PRIOR TO INSTALLATION. IN THE EVENT THE PLANT MATERIAL IS NOT AVAILABLE IN THE SIZE SPECIFIED, THE CONTRACTOR SHALL INSTALL LARGER AT NO COST TO OWNER.
- 14. THE LANDSCAPE CONTRACTOR SHALL OBTAIN WRITTEN APPROVAL FOR ALL PLANT MATERIAL SUBSTITUTIONS FROM THE LANDSCAPE ARCHITECT PRIOR TO INSTALLATION. PLANT SUBSTITUTIONS WITHOUT PRIOR WRITTEN APPROVAL THAT DO NOT COMPLY WITH THE DRAWINGS AND SPECIFICATIONS MAY BE REJECTED BY THE LANDSCAPE ARCHITECT AND REPLACED BY CONTRACTOR AT NO COST TO THE OWNER.
- 15. PRIOR TO MOBILIZATION THE CONTRACTOR SHALL NOTIFY THE LANDSCAPE ARCHITECT, IN WRITING, IF HE/SHE BELIEVES ANY OF THE PLANT MATERIAL IDENTIFIED ON THE PLAN MAY NOT BE SUITABLE FOR THE SITE OR MAY DIE. SUBSTITUTION REQUESTS WILL BE GRANTED BY THE LANDSCAPE ARCHITECT PRIOR TO THE START OF CONSTRUCTION ACTIVITIES. IF NOTIFICATION IS NOT GIVEN TO THE LANDSCAPE ARCHITECT ALL PLANTING WHICH FAILS TO GROW (EXCEPT FOR DEFECTS RESULTING FROM LACK OF ADEQUATE MAINTENANCE AS DETERMINED BY THE OWNER, NEGLECT, OR VANDALISM) SHALL BE REPLACED BY THE CONTRACTOR AT THE CONTRACTOR'S EXPENSE
- 16. WHERE PROPOSED TREE LOCATIONS OCCUR UNDER EXISTING OVERHEAD UTILITIES OR CROWD EXISTING TREES, NOTIFY LANDSCAPE ARCHITECT TO ADJUST TREE LOCATIONS.
- 17. ALL PLANT MASSES TO BE TOP DRESSED WITH MULCH AS SPECIFIED IN PLANT SCHEDULE, SPREAD UNIFORMLY IN DEPTH OVER THE PLANTING BEDS AS DELINEATED ON THE PLANS UNLESS OTHERWISE NOTED.
- 18. BED EDGE TO BE NO LESS THAN 12" AND NO MORE THAN 18" FROM OUTER EDGE OF PLANT MATERIAL BRANCHING. WHERE GROUND-COVER OCCURS, PLANT TO LIMITS OF AREA AS SHOWN.
- 19. ALL PLANTS SHALL BE GUARANTEED FOR 1 YEAR AFTER SUBSTANTIAL COMPLETION OCCURS AND FINAL ACCEPTANCE BY OWNER.
- 20. LANDSCAPE MAINTENANCE PERIOD BEGINS IMMEDIATELY AFTER THE COMPLETION OF ALL PLANTING OPERATIONS AND WRITTEN ACCEPTANCE FROM THE OWNER AND LANDSCAPE ARCHITECT. MAINTAIN TREES, SHRUBS, LAWNS, AND OTHER PLANTS AS PER THE PROJECT MANUAL AND/OR WRITTEN SPECIFICATIONS, IF APPLICABLE. LANDSCAPE MAINTENANCE IS THE LANDSCAPING CONTRACTORS RESPONSIBILITY UNTIL FINAL ACCEPTANCE BY THE OWNER.
- 21. ALL LANDSCAPE MAINTENANCE SHALL BE IN ACCORDANCE WITH LOCAL GOVERNING STANDARDS.
- 22. REFER TO PROJECT MANUAL OR WRITTEN SPECIFICATIONS, IF AVAILABLE, FOR ADDITIONAL REQUIREMENTS.

SOIL PLANTING MIXTURE (MIX ONSITE)

- 1. THE LANDSCAPE CONTRACTOR SHALL FURNISH FROM THEIR SOURCE A GOOD CLEAN, NATIVE SOIL WHICH SHALL MEET THE APPROVAL OF THE OWNER'S REPRESENTATIVE. THIS SOIL SHALL BE USED FOR THE PLANTING MIXTURE AS
- A. ONE PART COMPOST/MANURE PLANTING MIX, TOPSOIL OR APPROVED EQUAL
- B. ONE PART NATIVE SOIL

2. SOILS WITHIN PLANTING AREAS MUST BE SUITABLE FOR PROPOSED PLANTED MATERIAL & SOD WITH REGARD TO: pH, SOIL TEXTURE, SOIL STRUCTURE, AND SEASONAL HIGH WATER TABLE. THE CONTRACTOR SHALL ANALYZE EXISTING SOILS LOCATED IN PROXIMITY TO PROPOSED PLANT MATERIAL AND BE RESPONSIBLE TO AMEND THE SOIL TO OBTAIN ESSENTIAL REQUIREMENTS NECESSARY FOR THE ESTABLISHMENT AND GROWTH OF PLANT LIFE. LANDSCAPE CONTRACTOR TO PROVIDE SOILS REPORT AND APPROPRIATE RECOMMENDATIONS PRIOR TO INSTALLATION TO OWNER'S REPRESENTATIVE FOR REVIEW. FAILURE TO PROVIDE REPORT MAY RESULT IN PLANT MATERIAL BEING REJECTED BY OWNER'S REPRESENTATIVE AND REPLACED AT NO COST TO OWNER.

3. THE LANDSCAPE CONTRACTOR SHALL NOTIFY THE OWNER'S REPRESENTATIVE IN WRITING PRIOR TO PLANTING, WHEN CONDITIONS DETRIMENTAL TO PLANT GROWTH ARE ENCOUNTERED, SUCH AS RUBBLE FILL, POOR PLANTING SOIL, ADVERSE DRAINAGE CONDITIONS, OR OBSTRUCTIONS.





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ID Description

rzcarrollton,

Revisions / Submissions


Date

Project Number: 763658
Scale: AS SHOWN
Drawn By: JAL
Checked By: EAB
Date: 04.29.2024
Issue: NOT FOR CONSTRUCTION

Drawing Title:

LANDSCAPE DETAILS

L1.1

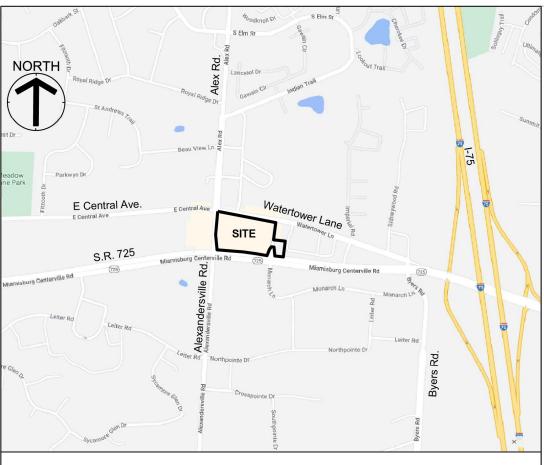

VICINITY MAP - NOT TO SCALE

EXHIBIT "A" LEGAL DESCRIPTION (See surveyor notes for Title Commitment information.)

Situated in the city of West Carrollton, County of Montgomery, state of Ohio: And known as being Lots numbered 2303, 2304 and 2305 of the consecutive lot numbers of said city of West Carrollton, and being a tract of land more particularly described as follows:

beginning at a spike at the intersection of the centerline of Water Tower Lane with the east right-of-way line of Alex Road;

Thence from said point of beginning, south 80 deg. 04' 29" east with said centerline a distance of 681.78 feet to a spike at the northwest corner of City Lot No. 2302;

Thence south 6 deg. 04' 31" west with the west line of said Lot 2302 a distance of 199.82 feet to an iron pin at the southwest corner of said lot; Thence south 84 deg. 25' 00" east with the south line of said lot a distance of 135.00 feet to an iron pin at a corner of City Lot No. 4106; Thence south 6 deg. 11' 42" west with the west line of said Lot 4106 a distance of 182.55 feet to an iron pin on the northerly right-of-way line of

Thence with said right-of-way on the following courses:

North 83 deg. 54' 59" west a distance of 97.46 feet to a point;

Thence north 6 deg. 01' 51" west a distance of 101.77 feet to a point;

Thence north 84 deg. 16' 59" west a distance of 32.00 feet to a point;

Thence south 34 deg. 28' 18" west a distance of 40.08 feet to a point;

Thence south 19 deg. 58' 27" west a distance of 74.17 feet to a point;

Thence north 80 deg. 56' 59" west a distance of 129.29 feet to a point;

Thence north 83 deg. 22' 59" west a distance of 148.39 feet to a point;

Thence north 86 deg. 33' 29" west a distance of 302.67 feet to an iron pin on the said right-of-way line of Alex Road;

Thence with said right-of-way on the following courses:

North 6 deg. 17' 29" west a distance of 174.03 feet to an iron pin; Thence north 3 deg. 56' 54" east a distance of 270.91 feet to the place of beginning, containing 6.663 acres, more or less, subject, however, to all legal easements, highways, and restrictions of record. The foregoing is a new description prepared by Thomas McDougall, registered surveyor, State

Parcel Number: K48-00415-0027

State Route 725;

SURVEYOR NOTES:

- 1. This survey does not constitute a title search by the surveyor. All information regarding record easements, and other documents that might affect the quality of title to the parcel shown hereon we obtained through a certified title commitment conducted by Stewart Title Guaranty Company, Commitment Number 2207561 and bearing an effective date of December 22, 2023 at 8:00 a.m.
- 2. Occupation in general matched the survey.
- 3. Horizontal Datum U.S. State Plane, NAD83 Ohio South (3402) established from using the Ohio Real Time Network (RTN) provided by the Ohio Department of Transportation. Coordinates taken to ground at latitude N39°38'31.85140", longitude W84°14'33.66892", project height 860.754', ground scale factor 1.00009516155015.
- 4. The utilities shown are located from field survey information and/or existing drawings supplied by client. The surveyor makes no guarantee that the utilities located comprise all such utilities in the area, either in service or abandoned. The surveyor further does not warrant that the utilities located are in the exact location indicated although the surveyor does certify that they are located as accurately as possible from information available. OUPS ticket no: A400901229-00A & A400901235-00A. Underground utilities marked by The Underground Detective.
- Parcel is located within Zone "X" (Area of Minimal Flood Hazard) as indicated by the Flood Insurance Rate Map (FIRM) Map Number 39113C0265E, effective date: January 6, 2005, published by the Federal Emergency Management Agency.
- 6. Direct access to the subject parcel is available via Watertower Lane and Alex Road, being public right-of-ways.
- 7. No evidence of recent earth movement, building construction, or building additions observed on the surveyed property at the time of the fieldwork.
- 8. No changes to street right-of-way lines were provided to the surveyor at the time of this survey.
- 9. There are 97 regular and 1 ADA accessible marked parking spaces on the surveyed property.

10. A zoning report was not provided to the surveyor at the time of the survey.
SURVEYOR'S CERTIFICATION:

TO: Stewart Title Guaranty Company, Sheetz, Inc., Pennsylvania corporation;

This is to certify that this map or plat and the survey on which it is based were made in accordance with the 2021 Minimum Standard Detail Requirements for ALTA/NSPS Land Title Surveys, jointly established and adopted by ALTA and NSPS, and includes Items 1, 2, 3, 4, 5, 6(a), 6(b), 8, 9, 11(a), 11(b), 12, 13, 14, 15, 16, 17, 19 and 20 of Table A thereof. The fieldwork was completed in

Date of Plat or Map: January 17, 2024

Sean T. Brooks, Ohio PS No. 8828 brooks@cesoinc.com 3601 Rigby Road Suite 300 Miamisburg, Ohio 45342 (937) 435-8584

January 2024.

(See surveyor notes for Title Commitment information.)

Items 1 - 9 and 17 - 23 are not survey related.

SHOWN HEREON.

- Easement granted to The Ohio Fuel Gas Company, as more fully set forth in the document recorded as Deed Book 1419, Page 159.
 EASEMENT IS BLANKET IN NATURE
- 11. Easement granted to The Dayton Power and Light Company, as more fully set forth in the document recorded as Deed Book 1514, Page 599.

 EASEMENT IS NOT ON THE SURVEYED PROPERTY AND NOT SHOWN HEREON.
- 12. Easement granted to Joe L. Thompson and Jo Ann Thompson, as more fully set forth in the document recorded as Deed Book 1987, Page 733.

 EASEMENT IS NOT ON THE SURVEYED PROPERTY BUT SHOWN HEREON.
- Easement granted to the State of Ohio, as more fully set forth in the document recorded as Deed Book 2121, Page 23.
 EASEMENT IS NOT ON THE SURVEYED PROPERTY AND NOT
- 14. Easement granted to the State of Ohio, as more fully set forth in the document recorded as Deed Book 2128, Page 18.
 EASEMENT IS NOT ON THE SURVEYED PROPERTY BUT SHOWN
- 15. Easement granted to The Dayton Power and Light Company, as more fully set forth in the document recorded as Instrument 80-127C12. EASEMENT IS NOT ON THE SURVEYED PROPERTY BUT SHOWN
- 16. Terms, provisions and conditions contained in Memorandum of Lease by and between Imperial Square, landlord, and Lojo III, Inc., tenant, dated August 6, 1976 and recorded January 25, 1977 as Instrument 77-071A02 and all rights thereunder of and all acts done or suffered thereunder of said lessee or any parties claiming by, through or under said lessee; as assigned and amended in Instrument 01-2305C03; with the Assignment and Assumption of Lease of record in Instrument 08-052796.
- THE SURVEYED PROPERTY IS DESCRIBED IN THE DOCUMENT. NO EASEMENTS ARE DESCRIBED.

PENCHMARK Vertical Datum: NAVD88 derived from GPS Observations BM "A": Bench tie set in a light pole located on the west side of the site approximately 3' east of the east curb of Alex Road and 13' north of a concrete entranceway to the shopping center. Elevation = 974.86' BM "B": Cross notch set on a light pole located in a parking lot neat the center of the site Elevation = 975.87' BM "C": Cross notch set on a hydrant located on the north side of the site, approximately 4 feet south of the curb along the south right-of-way line of Watertower Lane and 22' east of a 35

SURVEY MONUMENT LEGEND

- 5/8" Iron Pin Set w/cap CESO, Inc	Rec. (R) - Dee

⊚ - Iron Pin Found as Described∅ - PK Nail/Mag Nail Found

mph sign.

Elevation = 972.46'

✓ - PK Nail/Mag Nail Set♦ - Benchmark Set

TOPOGRAPHIC LEGEND


Power / Telephone Pole	ϕ Signal Pole		
⊈ Light Pole	(— Guy Wire		
ϕ Power Pole	E Electric Meter		
☐ Electric Box (Access)	∃ <i>G</i> Gas Line Marker		
Gas Valve			
⊚ Cleanout	⊗ Water Valve		
S Sanitary Manhole	Cable Box		
① Storm Manhole	□ Telephone Box		
E Curb Inlet	o Bollard		
■ Catch Basin	√ Sign		
#### Structure Number	Deciduous Tree		
	Pine Tree		
G	Gas Line (Per Plan)		
w	Water Line (Per Plan)		
UGE	Underground Electric (Per Plan)		
UGT	Underground Communications (Per Plan)		
OHL	Overhead Utility Line		

Storm Sewer


Fence Line

———— SAN ———— Sanitary Sewer

Handrail

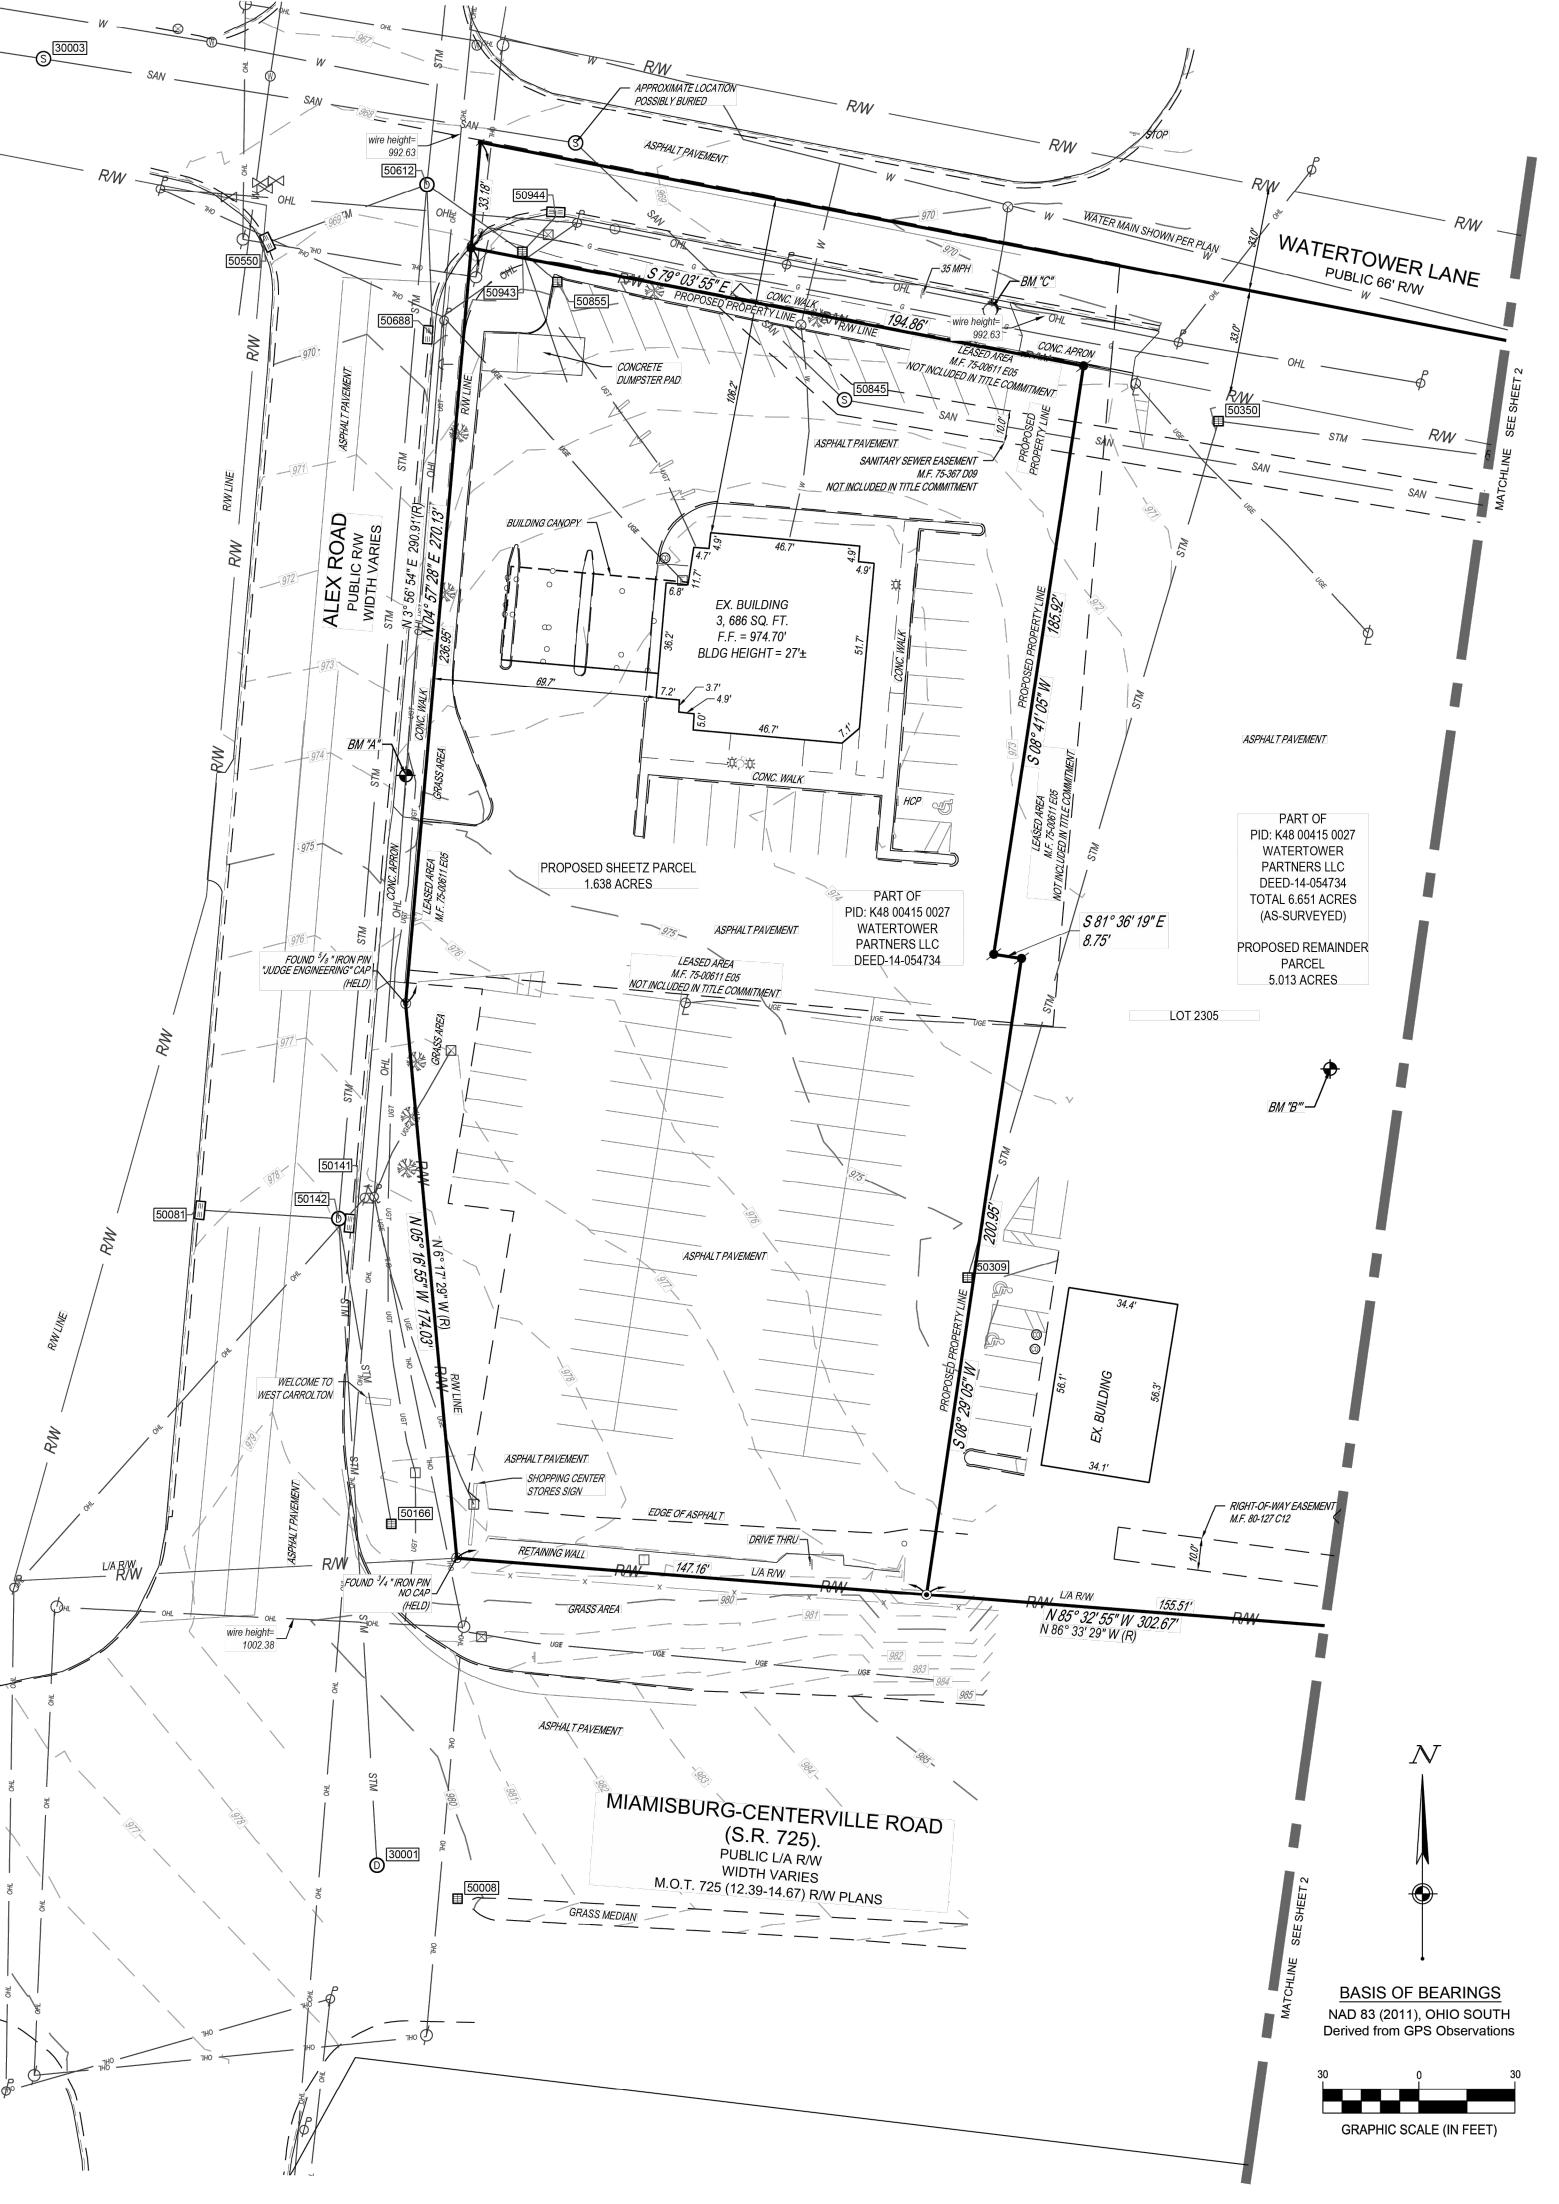



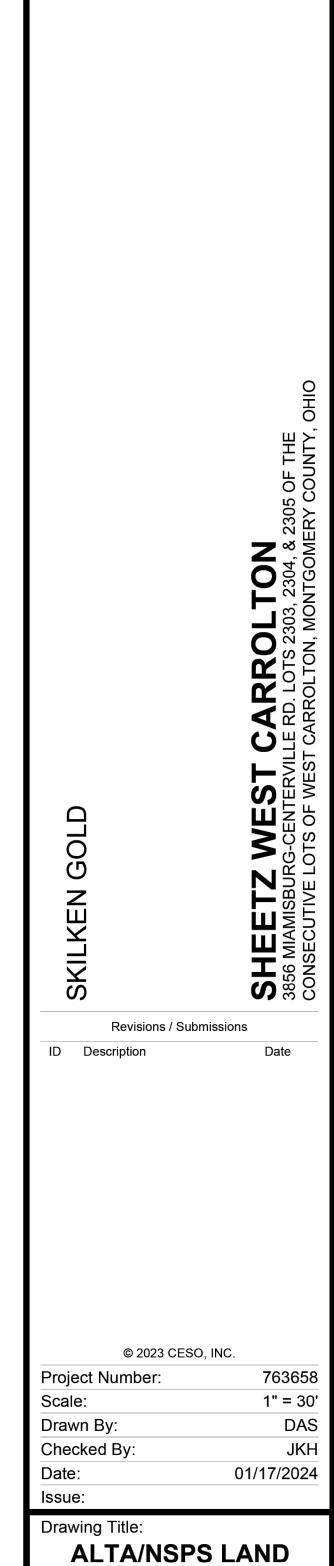

TITLE SURVEY

C1.1